



**CITY OF SACRAMENTO
CALIFORNIA**

PLANNING AND BUILDING
DEPARTMENT
(916) 264-5381

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SACRAMENTO, CA 95814-2998



ACTION OF THE PLANNING DIRECTOR

On May 20, 2004, the Planning Director approved with conditions a special permit for four house plans on 128 lots and a model home complex for the project known as Sterling Hills at Natomas Creek in the Natomas Creek PUD (P04-037). Findings of Fact and conditions of approval for the project are listed on pages 5 through 8.

Request: **A. Planning Director's Special Permit** for four house plans on 128 lots at Sterling Hills at Natomas Creek
 B. Model Home Complex for four model homes, sales office and parking lot

Location: Southwest of Elkhorn Boulevard and East Commerce Way
 Sterling Hills at Natomas Creek in the Natomas Creek PUD
 APN: 201-0300-026, -029
 North Natomas Community Plan
 Rio Linda Union School District, Grant Joint Union High School District
 Council District 1

APPLICANT:	Cori Van Dyck, (916) 965-2200 x242 D.R. Horton 4401 Hazel Avenue, Suite 225, Fair Oaks, CA 95628
OWNER:	D.R. Horton 4401 Hazel Avenue, Suite 225, Fair Oaks, CA 95628
PLANS BY <i>(optional)</i> :	Bloodgood Sharp Buster (BSB) Architects 1117 Windfield Way, Suite 110, El Dorado Hills, CA 95762
APPLICATION FILED:	February 20, 2004
APPLICATION COMPLETED:	May 6, 2004
STAFF CONTACT:	David Hung, (916) 808-5530

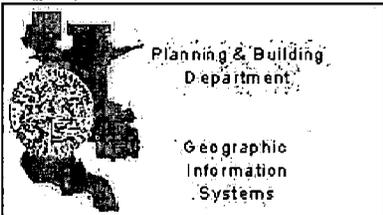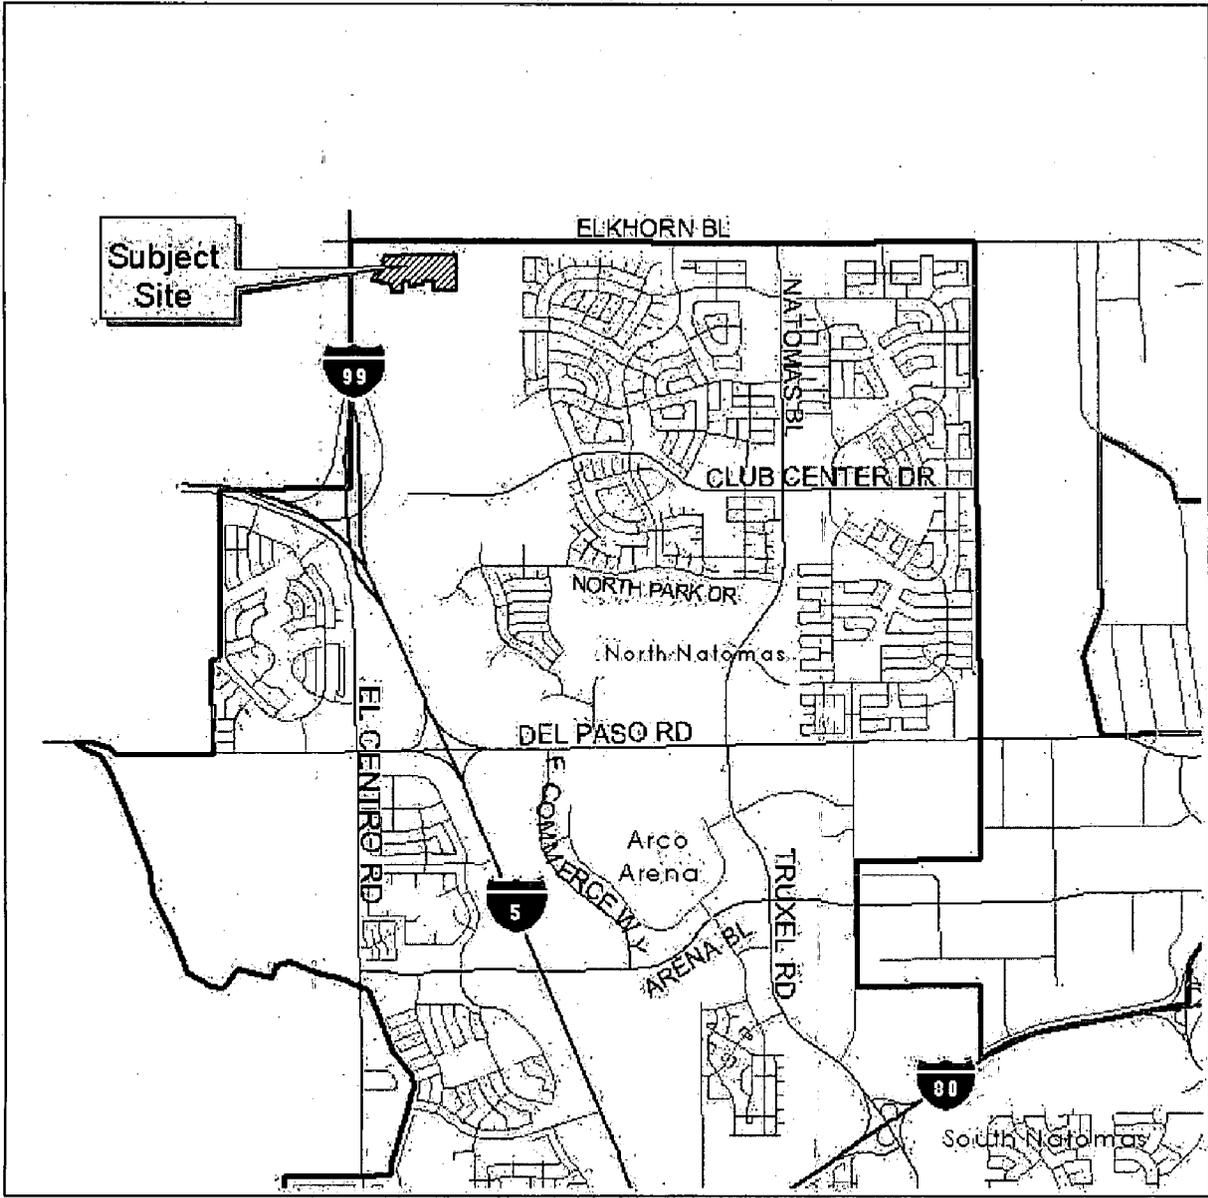

Planning & Building
Department

Geographic
Information
Systems

April 12, 2004



Vicinity Map
P04-037
Sterling Hills
at Natomas Creek



PROJECT INFORMATION:

General Plan Designation: Low Density Residential (4-15 du/na)
Community Plan Designation: Low Density Residential (3-10 du/na)
Existing Land Use of Site: Vacant
Existing Zoning of Site: Standard Single-Family (R-1) Planned Unit Development (PUD)
Subdivision & Village: Sterling Hills at Natomas Creek (Lots 3001-3098, 3104-3109, 1082-1100, 1127-1131) in Natomas Creek PUD
Property Area: 28± gross acres
Square Footage of Buildings: 2,166 to 3,306 square feet

House Plan	Square Footage	Elevations
Plan 1	2,166	Spanish, Italian, French
Plan 2	2,292	Spanish, Italian, French
Plan 3	2,907	Spanish, Italian, French
Plan 4	3,306	Spanish, Italian, French

Height of Building: One story (Plans 1 & 2), two stories (Plans 3 & 4)
Exterior Building Materials: Stucco, stucco trim
Roof Materials: Concrete tile
Previous Files: P98-041
Project Plans: See Exhibits 1 through 15

ADDITIONAL INFORMATION:

This is a Planning Director's Special Permit (PDSP) approval to develop four house plans on 128 lots along with a model home complex in Sterling Hills at Natomas Creek in the Natomas Creek Planned Unit Development. After the above approval, a building permit will be required prior to the construction of the residential development.

PROJECT EVALUATION:

House Plan	Level of Compliance	Comments
Plan 1	Non-Compliant	Split-garage without mitigation
Plan 1 (Suite Option)	Compliant	Living area in front of forward facing garage
Plan 2	Compliant	Living area in front of forward facing garage
Plan 3	Compliant	Living area in front of forward facing garage
Plan 4	Compliant	Living area in front of forward facing garage

Staff finds that generally the proposed house plans comply with all applicable General Plan, Community Plan, Zoning Ordinance requirements, Natomas Creek PUD Guidelines, and that they

generally meet the intent of the Single Family Residential Design Guidelines. The proposed model home complex shall be built as specified under the Conditions of Approval.

ENVIRONMENTAL DETERMINATION:

On September 28, 1999, the City Council adopted the Negative Declaration and Mitigation Monitoring Plan for the original project (P98-041). Potentially significant environmental issues regarding Air Quality, Animal Life, Noise, Transportation/Circulation, Human Health and Cultural Resources were discussed and mitigated in this document. The proposed project was analyzed in this previous environmental document. No new issues or new information is known that would trigger additional environmental analysis. The Adopted Negative Declaration adequately described the effects of the proposed development. The analyses and mitigation measures in the adopted Negative Declaration are reaffirmed. Section 15162 of the California Environmental Quality Act Guidelines provides that an additional Negative Declaration (or Environmental Impact Report) need not be prepared unless subsequent changes are proposed in the project, substantial changes occur with respect to the project circumstances, or new information of substantial importance to the project becomes known or available. A Mitigation Monitoring Plan was prepared for the mitigation measures identified in the previous Negative Declaration. The applicant shall comply with the Mitigation Monitoring Plan, when applicable to the proposed project.

NEIGHBORHOOD/AGENCY COMMENTS:

The applicant mailed a public notice to adjacent property owners on January 12, 2004. No comments have been received from the public notice.

The Natomas Community Association (NCA) has reviewed the project plans on December 10, 2003 and had the following comments: *(Staff comments are in italics.)*

1. Color schemes for at least one project (Sterling?) are varied and we preferred them to the other project schemes that seemed to be based on off-white and gray.
2. It is nice to see that most of the floor plans have front porches and living-rooms or dining-rooms at the front of the house providing a view of street activity.
3. Both side elevations on Sterling Hills plan 3 have large expanses without architectural features. This plan should not be located on corner lots unless the elevations are improved to provide interest, e.g. add double-hung or sliding windows, clerestory windows, and under-cabinet window as needed. *Project is conditioned to provide enhanced side and rear elevations whenever either of those elevations faces a public street, school, park, canal, or other public space.*
4. "Typical Production Home Landscape Plans" should identify the acceptable street trees.
5. It appears that trees numbered 13-16 are provided as garden trees. We suggest deleting the magnolia grandiflora from the list unless it is identified for use only on north- and east-facing locations and not within the P.U.E. Also delete Ulmas Parvifolia from garden list and place it on street tree list.
6. It is important to provide convenient pedestrian access to the open space along SR-99 and Elkhorn Boulevard. *Project is conditioned to provide pedestrian access on 'C' Court, 'E' Court and 'G' Court to the open space buffer on the south side of Elkhorn Boulevard.*
7. Are homes on the western edge of the subdivision facing a wall? There should be a significant landscaped space between the street and the wall, while maintaining the 100-foot wide open space between the freeway and the wall.

Kern Schumacher, the property owner of Natomas Creek PUD, has reviewed and approved the project plans for Sterling Hills as stated on a letter dated February 11, 2004 from the Law Offices of Gregory D. Thatch, attached as Exhibit 16.

CONDITIONS OF APPROVAL:

A: Planning Director's Special Permit for 128 residential units is approved subject to the following conditions:

- A1. Plans shall be consistent with elevations attached in Exhibits 3 through 6.
- A2. All of the house plans submitted and approved with this PDSP application shall be actively marketed and offered for sale within the subdivision/village(s) covered by this approval (P04-037).
- A3. Any change in the design, materials, or colors shall be submitted to the Planning Director for review and approval.
- A4. Two plot plans consistent with the approved Final Map (P98-041) shall be submitted to Building Division demonstrating compliance with setbacks, and lot coverage (including the use of allowances/incentives as specified in the PUD Guidelines) for all lots included in this approval. All building elevations shall demonstrate compliance with roof pitch and enhancement requirements as specified in the Natomas Creek PUD Guidelines.

Required Setbacks (for Low Density Residential - Traditional Lots):

- Front: 12'-6" minimum to front of porch or house
20'-0" minimum to front of garage
- Side: 5'-0" minimum on each side (with the exception of zero-lot line conditions, which shall be 5'-0" and 0")
- Side Street: 12'-6" minimum
- Rear: 15'-0" minimum

Lot Coverage: The lot coverage shall not exceed 45 percent for single story homes and 40 percent for two story homes, given allowances/incentives described in the Natomas Creek PUD Guidelines (P98-041).

- A5. Enhanced side and rear elevations shall be required whenever either of those elevations faces a public street, school, park, canal, or other public space. Enhanced elevations shall include, at a minimum, "pop-outs" around windows and doors consisting of stucco over foam trim, finished with a texture that is different from the texture of the house, or other appropriate door and window trim features; and a four foot return of materials on the side or rear elevations, as appropriate. On enhanced side and rear elevations, window treatments, rooflines, and materials shall match front facade in appearance and quality. All enhanced elevation treatments shall be shown on the plans submitted for building permit.
- A6. All windows on enhanced side and rear elevations for all house plans on this application shall have grid pattern to match the respective front elevations.
- A7. Roofing shall be as shown on plans.

- A8. Prior to building permit issuance for lots with zero lot lines, the applicant shall enter into and record an Agreement for Conveyance of Easements with the City stating that a five (5) foot private access and maintenance easement shall be conveyed to and reserved for the lot adjacent to the zero lot line, at no cost, at the time of sale or other conveyance of either parcel.
- A9. No two house plans shall be placed on adjacent lots, unless they are of different elevations. Applicant shall provide to the Building Division a map that indicates plan and elevation on adjacent lots.
- A10. On corner lots, the driveway shall be located away from the intersections of streets.
- A11. On corner lots, fencing shall start at or near the rear corner of the house or acceptable to the Planning Director.
- A12. The applicant shall comply with the Natomas Creek TSMAC Plan for residential development.
- A13. Install an average of two 15-gallon trees along the street frontage of each unit. In addition, along side yards adjacent to public streets, install an average of one 15-gallon tree for each 30' of street frontage.
- A14. Front landscaping and irrigation system shall be provided and consistent with the Natomas Creek PUD Guidelines.
- A15. On corner lots, the builder shall provide special landscaping treatments by providing accent trees and shrubs along the side yard fence.
- A16. All landscaping and planting shall conform to City standards for sight line requirements at intersections and driveways.
- A17. Walls and fences shall be consistent with the PUD Guidelines and shall conform to City standards for sight line requirements at intersections and driveways.
- A18. Driveways shall comply with maximum paved area as permitted in the PUD Guidelines and Title 17 of the City Code.
- A19. Garages: Each house shall provide at least one garage space with minimum inside dimensions of 10 wide by 20 feet long, as required by Title 17 of the City Code.
- A20. Provide pedestrian access on 'C' Court, 'E' Court and 'G' Court to the open space buffer on the south side of Elkhorn Boulevard.
- A21. The applicant shall comply with the originally approved Mitigation Monitoring Plan (P98-041) on file at the Planning Division.
- A22. Prior to the issuance of the 150th building permit for the project known as Sterling Hills (P04-037), or the first certificate of occupancy or the final permit of said project, whichever comes first, the applicant shall initiate and complete the formation of a parks maintenance district (assessment or Mello-Roos special tax district), or annex the project to an existing

parcs maintenance district. The applicant shall pay all city fees for formation of or annexation to special districts. The purpose of the district is to equitably spread the cost of neighborhood parks maintenance on the basis of special benefit, in the case of an assessment district. In the case of a special tax district, the costs will be spread based upon a hearing report which specifies the tax rate and method of apportionment.

A23. This approval is for 128 lots within Sterling Hills at Natomas Creek. Any increase in the number of lots or any modification to the location of the lots specified for these house plans shall be reviewed by the Planning Director and may require additional entitlements.

A24. The applicant shall obtain all necessary building permits prior to commencement of construction; and building permits shall not be issued unless the Final Map has been approved.

B. Model Home Complex is approved subject to the following conditions:

B1. The four model homes and a parking lot on Lots 1082, 1083, 1084, 1085, 1086 shall be consistent with attached Exhibits 8 through 15. A sales office will be situated in the Plan 1 model home on Lot 1083.

B2. All model homes shall comply with the requirements for Natomas Creek PUD and the conditions per the respective PDSP application (P04-037), inclusive of lot coverage, height and setback requirements; the lot coverage shall not exceed 45 percent for single story homes and 40 percent for two story homes, given allowances/incentives described in the Natomas Creek PUD Guidelines (P98-041). All permanent accessory structures, including trellises, shall meet height, setback and lot coverage requirements per the Zoning Ordinance; no portion of any accessory structure shall extend across property lines.

B3. Parking area shall be paved to the standards in Section 17.68.020(A) of the Zoning Code. No gravel lots will be allowed. A four foot landscaped planter is required if the parking area is adjacent to the public right-of-way.

B4. Trap Fence shall not be located within the public right of way such as sidewalk and roadway.

B5. Upon expiration of this permit, or upon completion of the use of the model homes for display, whichever happens first, the trap fence, trap walk, paved parking area, any signage, temporary landscaping and temporary outdoor fixtures or structures (including trellis and planters) shall be removed; the sales office shall be restored to a garage and driveways for each home shall be built.

B6. In compliance with the drought tolerant landscaping requirement for model home complexes of three or more models, a Water Conservation Landscape and Irrigation plan has been submitted and approved by the City Landscape Architect on May 13, 2004. The model home on Lot 1084 will be drought tolerant.

B7. Per City Landscape Architect, install additional water conservation sign in the rear yard of drought tolerant Lot 1084.


B8. All necessary building permits and sign permits shall be obtained for construction.

- B9. The model home complex/temporary sales office permit shall be valid for two years from the date of its issuance. The zoning administrator may renew the permit for up to additional one-year periods upon written application at least 30 days prior to expiration.


FINDINGS OF FACT:

1. The project is based upon sound principles of land use in that the site is designated single family residential and the project to be developed consists of single-family homes.
2. The proposed development will not be detrimental to the public health, safety or welfare in that the residential development is consistent with the adopted PUD Guidelines and Schematic Plans for Natomas Creek and will comply with the required setbacks, height and lot coverage.
3. The proposed residential development is consistent with the objectives of the General Plan and the 1994 North Natomas Community Plan in that:
 - a. The project complies with the land use designations;
 - b. The project complies with density and open space proximity requirements of the North Natomas Community Plan;
 - c. The project continues to fulfill the North Natomas Community plan of providing neighborhoods that are focused on an elementary school, provides for a variety of housing densities and types with commercial, civic, transit and park uses in close proximity.
 - d. The project advances transportation and air quality goals.

Prepared By:

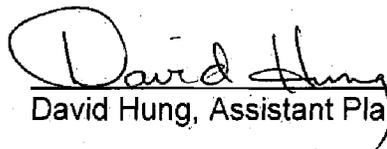
David Hung, Assistant Planner

Approved By:

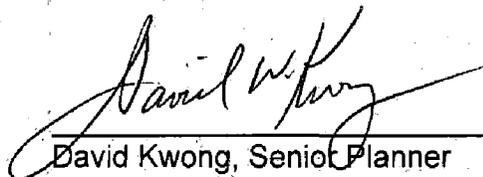
David Kwong, Senior Planner



- Attachments:
- Land Use and Zoning Map
 - Exhibit 1: Site Plan – Natomas Creek Villages 1 to 3
 - Exhibit 2: Site Plan – Sterling Hills
 - Exhibit 3: Corner Lot and Interior Lot Layouts – Plans 1 to 4
 - Exhibit 4: Floor Plan & Elevations (A), (B), (C) – Plan 1
 - Exhibit 5: Floor Plan & Elevations (A), (B), (C) – Plan 2
 - Exhibit 6: Floor Plan & Elevations (A), (B), (C) – Plan 3
 - Exhibit 7: Floor Plan & Elevations (A), (B), (C) – Plan 4
 - Exhibit 8: Model Homes Staking and Paving Plan
 - Exhibit 9: Model Homes Tree Planting Plan
 - Exhibit 10: Sprinkler Irrigation Plan, Schedule and Calculations
 - Exhibit 11: Planting Details
 - Exhibit 12: Sprinkler Irrigation Details
 - Exhibit 13: Trellis and Wood Screen Details
 - Exhibit 14: Fountain and Seat Walls Details
 - Exhibit 15: Landscape and Irrigation Specification
 - Exhibit 16: Natomas Creek PUD Approval Letter
 - Exhibit 17: Letter of Agreement

A use for which a Special Permit is granted must be established within two years after such permit is approved. If such use is not so established the Special Permit shall be deemed to have expired and shall be null and void. A Special Permit use which requires a Building Permit shall be deemed established when such Building Permit is secured and construction thereunder physically commenced. If no building permit is required, the use shall be deemed established when the activity permitted has been commenced.

The decision of the Planning Director may be appealed to the Planning Commission. An appeal must be filed within 10 days of the Planning Director's decision. If an appeal is not filed, the action of the Planning Director's decision is final.

cc: File
Applicant
Development Services - Building Division
PUD Binder

Land Use & Zoning Map

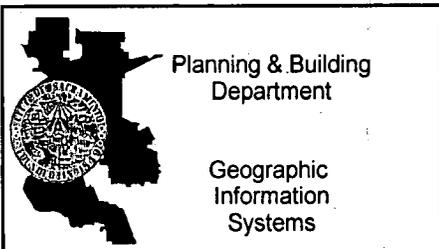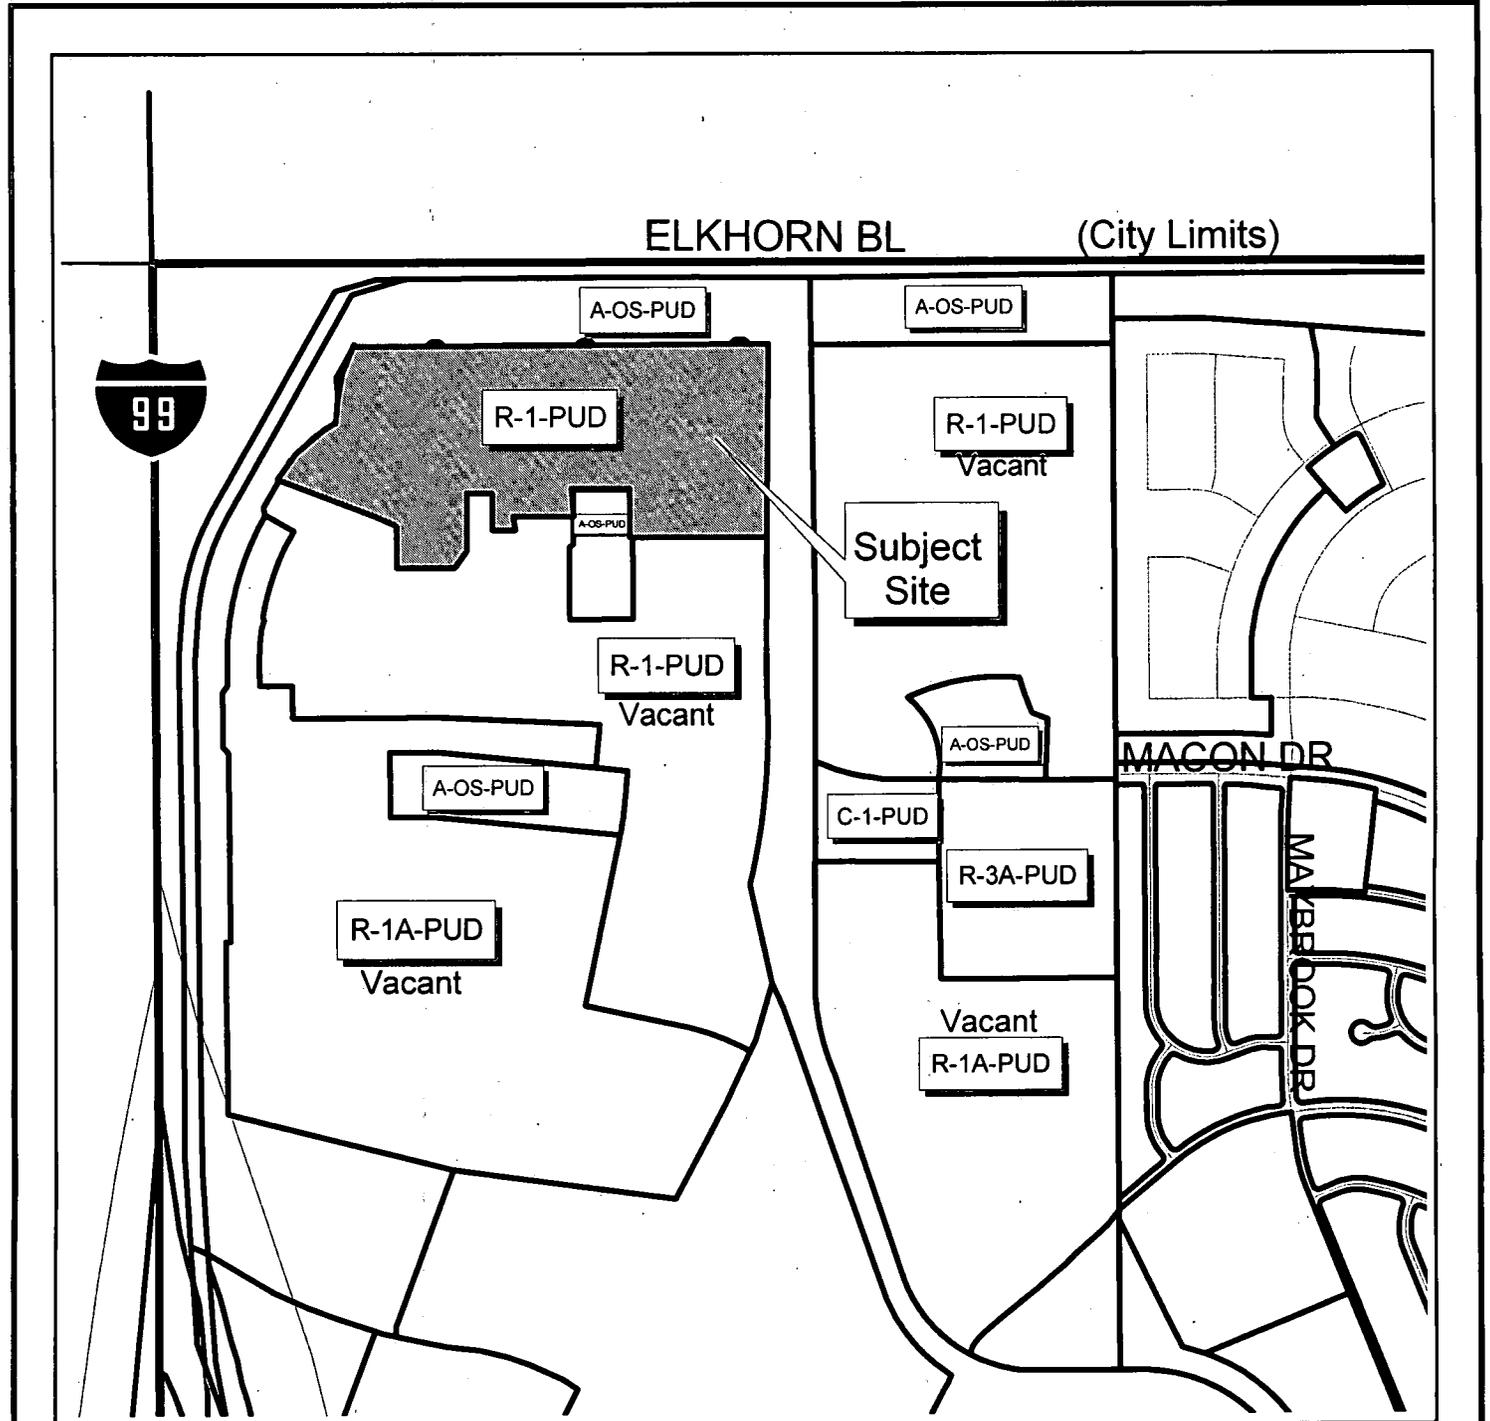

February 25, 2004

Land Use & Zoning Map
P04-037
Sterling Hills at Natomas Creek



Exhibit 1: Site Plan -
Natomas Creek Villages 1-3

ILLUSTRATIVE MAP NATOMAS CREEK

CITY OF SACRAMENTO, CALIFORNIA
JUNE 24, 2003

ELKHORN BOULEVARD

Village 3
Low Density
Residential
24.359± Ac.
109 - 65'x100' (TYP.) Lots

Lot B
Freeway Buffer
6.004± Ac.

Village 1
Low Density
Residential
53.153± Ac.
14 - 45'x100' (TYP.) Lots
243 - 55'x100' (TYP.) Lots
24 - 65'x100' (TYP.) Lots

Village 2
Low Density
Residential
15.249± Ac.
100 - 45'x100' (TYP.) Lots

Lot F
Canal
6.174± Ac.

Lot A
Open Space
9.032± Ac.

Lot C
Park
2.33± Ac.

Lot D
Park
4.014± Ac.

Lot E
School
9.951± Ac.


UNIT SUMMARY	
VILLAGE 1	281
VILLAGE 2	100
VILLAGE 3	109
TOTAL	490

P04-037


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Exhibit 2: Site Plan - Sterling Hills


SCALE: 1" = 100'

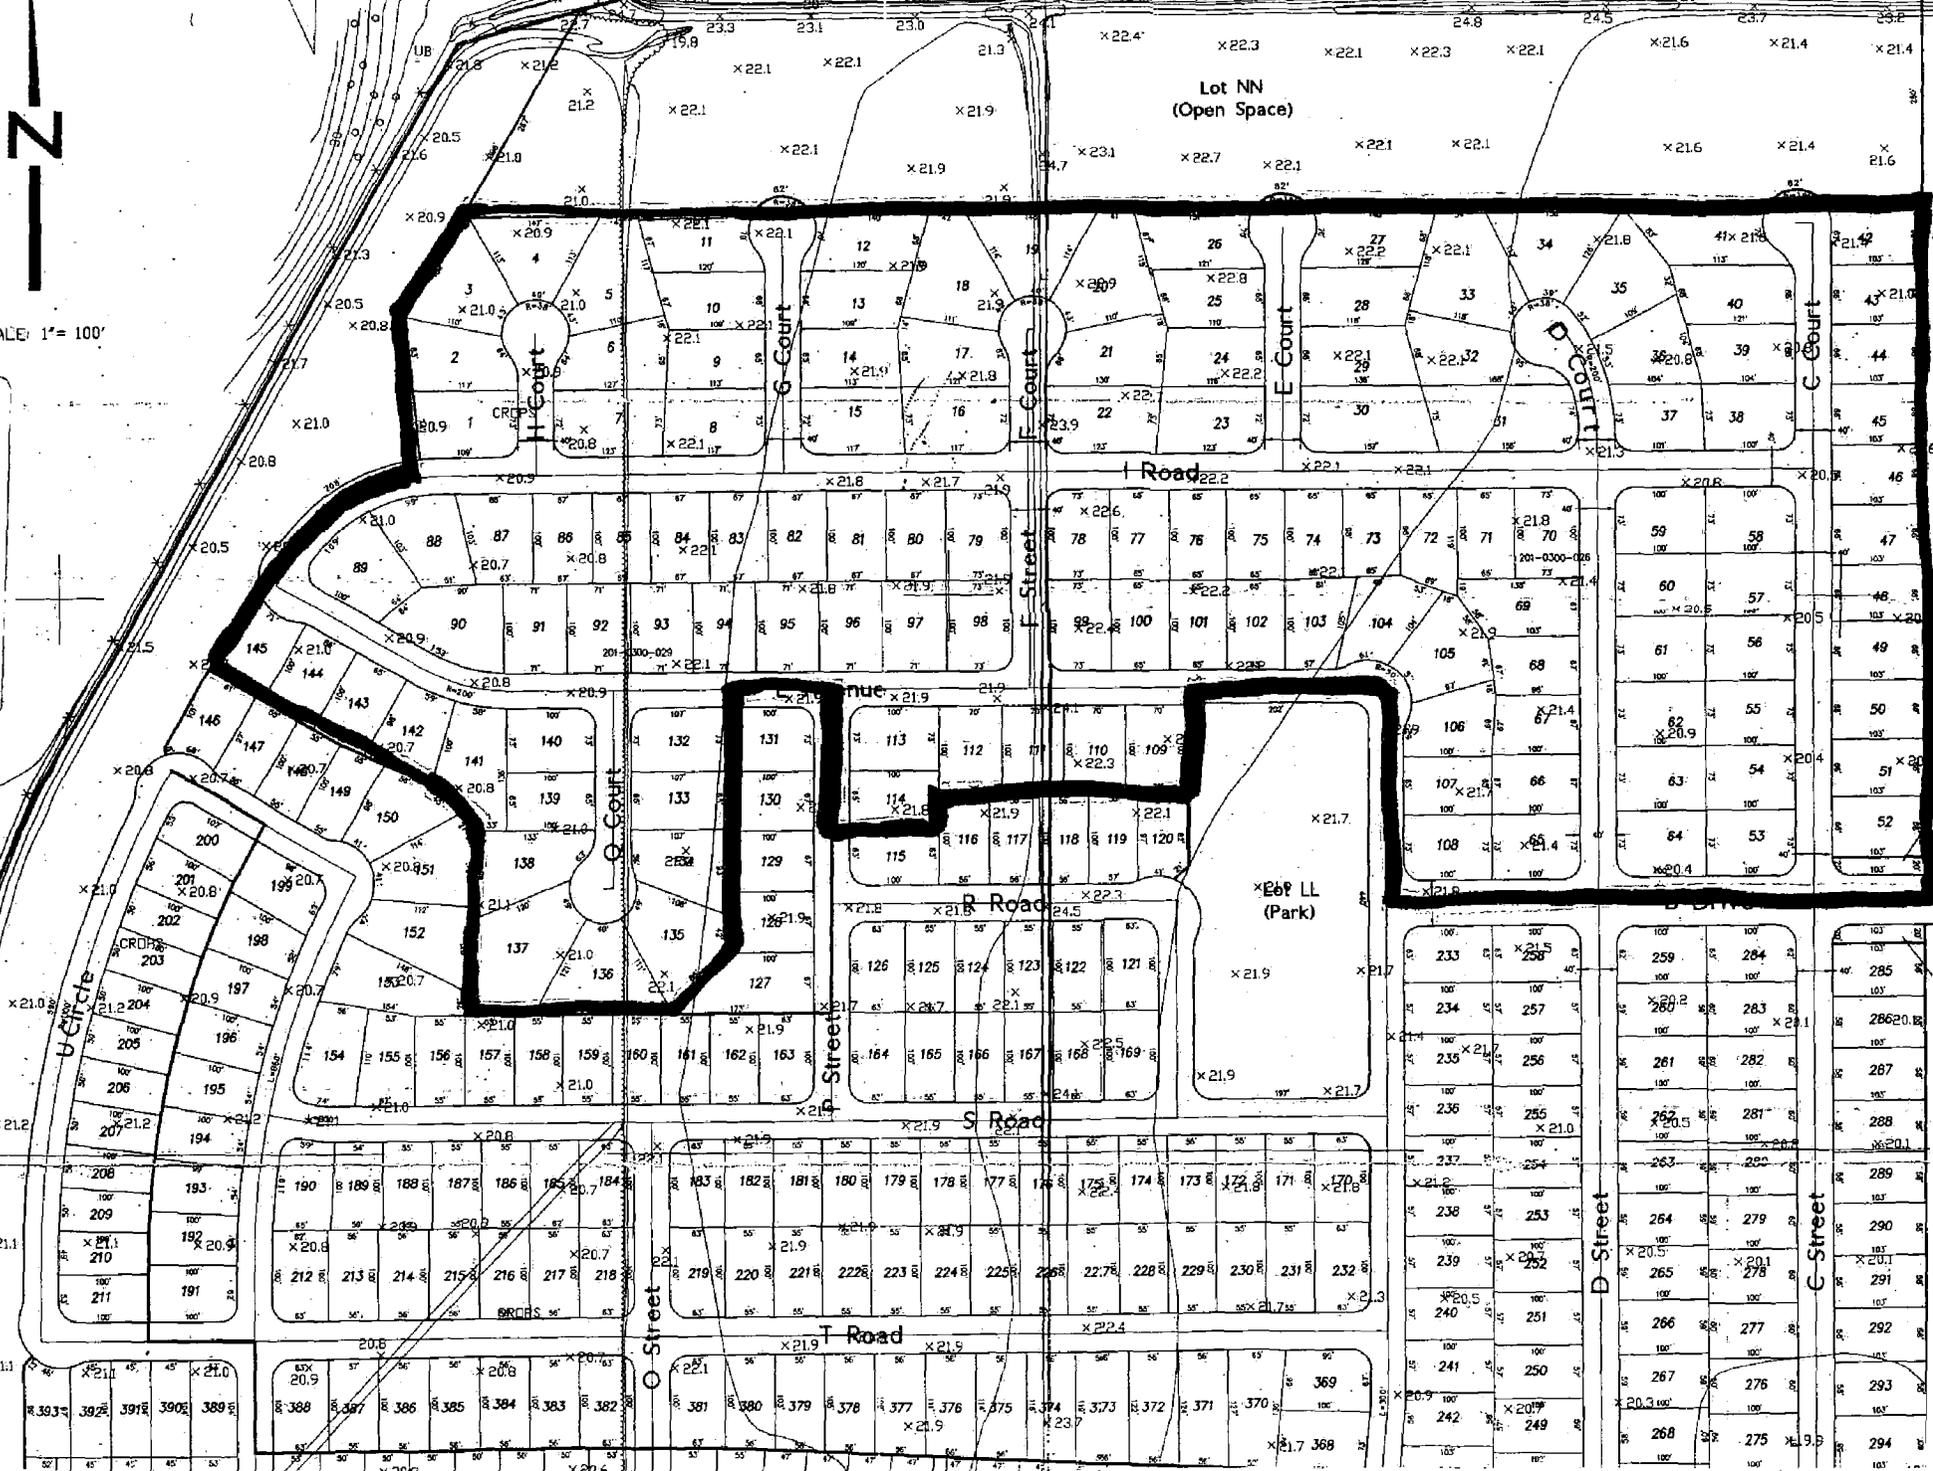

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THIS PLOT PLAN IS NOT FOR SALES PURPOSES. THIS PLOT PLAN IS FOR THE PURPOSE OF INDICATING COMPLIANCE WITH ZONING SET BACKS, GENERAL DRAINAGE AND APPROXIMATE UTILITY CONNECTION, ALL OTHER DATA SHOWN HEREON IS CONCEPTUAL. THIS PLOT PLAN DOES NOT REFLECT AS-BUILT CONDITION, RETAINING WALLS ARE OPTIONAL, AND MAY OR MAY NOT BE CONSTRUCTED.

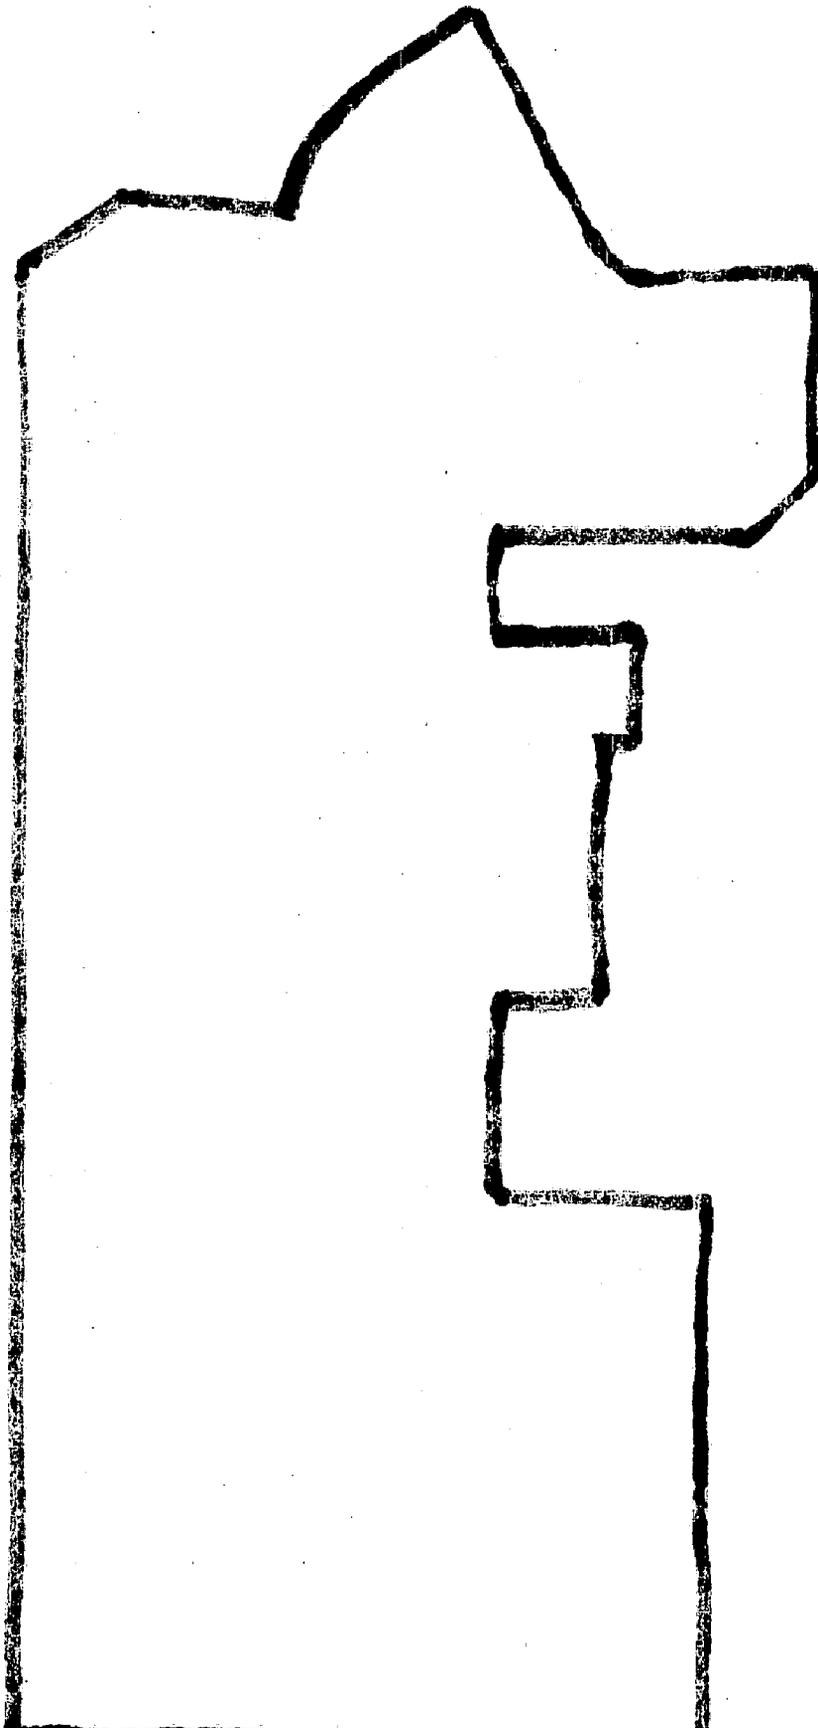

LEGEND

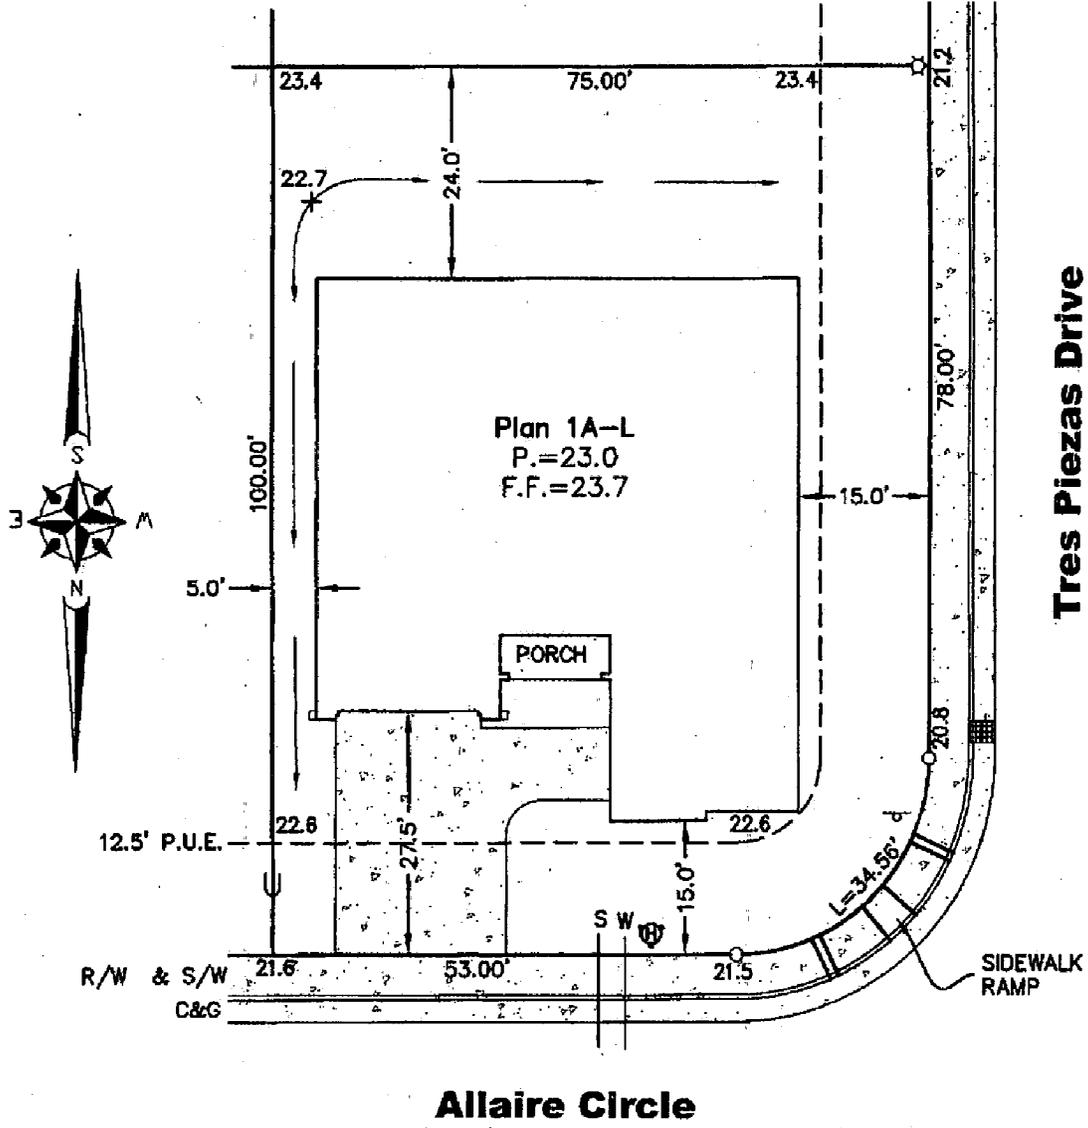- U - - - - UTILITY LOCATION
- ⊗ - - - - AIR CONDITIONER
- S - - - - SEWER
- W - - - - WATER
- ⊕ - - - - FIRE HYDRANT
- ⊙ - - - - STREET LIGHT
- ⊙ - - - - STREET SIGN
- ⊙ - - - - DRAIN INLET
- - - - - DIMENSION POINT



NET LOT AREA = 7,396 SQ. FEET
 FOOTPRINT AREA = 2,819 SQ. FEET
 LOT COVERAGE = 38%

SCALE: 1" = 20'

**PLOT PLAN
LOT 94**
 Natomas Creek Village 1
 Sterling Hills - Phase 1
 City of Sacramento, State of California

**WECKER
SURVEYS**
 1111 KENNEDY PLACE
 SUITE 4
 DAVIS, CA 95616
 530-792-7252
 FAX 530-758-2775

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LEGEND

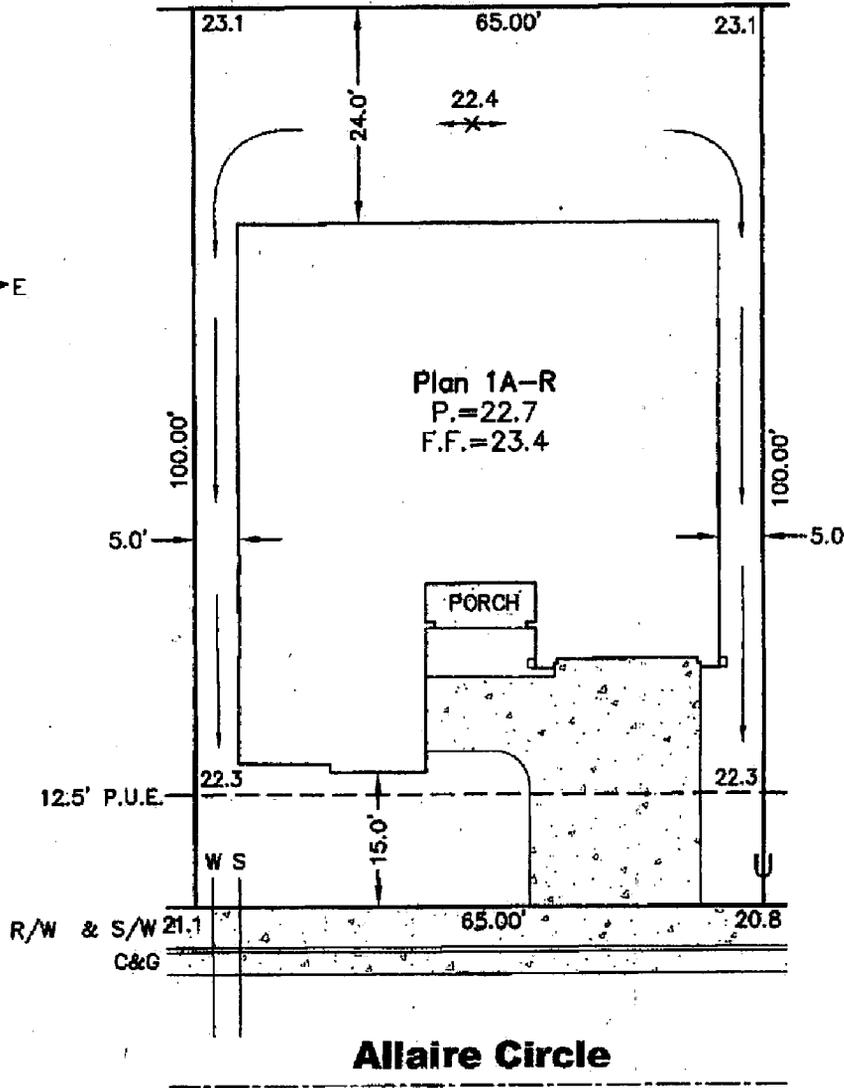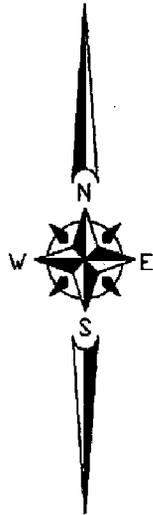- U - - - - UTILITY LOCATION
- ☒ - - - - AIR CONDITIONER
- S - - - - SEWER
- W - - - - WATER



SCALE: 1" = 20'

**PLOT PLAN
LOT 90**
Natomas Creek Village 1
Sterling Hills - Phase 1
City of Sacramento, State of California

**WECKER
SURVEYS**

1111 KENNEDY PLACE
SUITE 4
DAVIS, CA 95616
530-792-7252
FAX 530-758-2775

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LEGEND

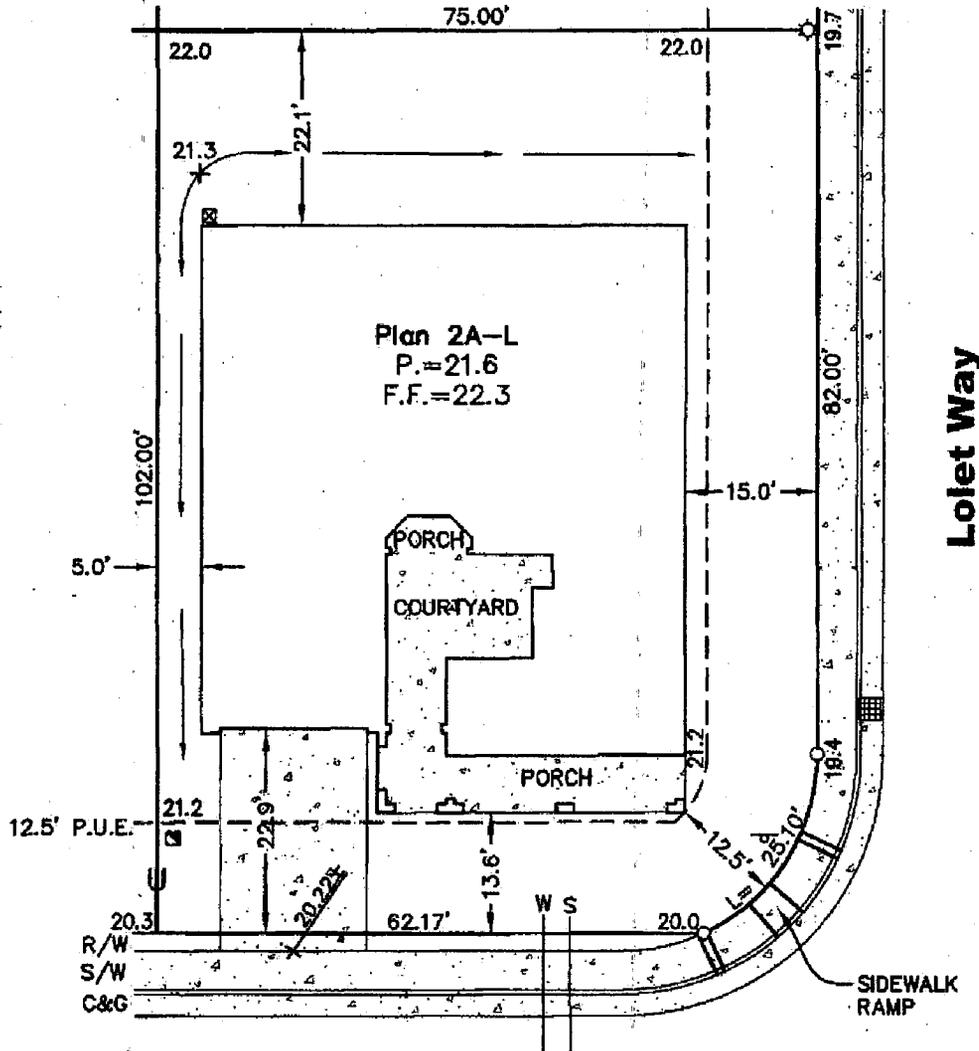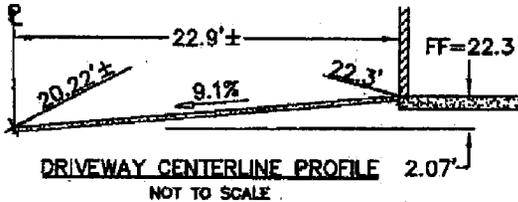- U - - - - UTILITY LOCATION
- ⊠ - - - - AIR CONDITIONER
- S - - - - SEWER
- W - - - - WATER
- O - - - - DIMENSION POINT
- ⊙ - - - - STREET LIGHT
- ⊕ - - - - STREET SIGN
- ▣ - - - - DRAIN INLET
- ▣ - - - - SUREWEST VAULT

Mike Waldron Drive


NET LOT AREA = 7,578 SQ. FEET
 FOOTPRINT AREA = 2,917 SQ. FEET
 LOT COVERAGE = 38%

SCALE: 1" = 20'

PLOT PLAN
 LOT 1100
 Sterling Hills at Natomas Creek
 City of Sacramento, State of California

WECKER SURVEYS
 1111 KENNEDY PLACE
 SUITE 4
 DAVIS, CA 95616
 530-792-7252
 FAX 530-758-2775

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Allaire Circle

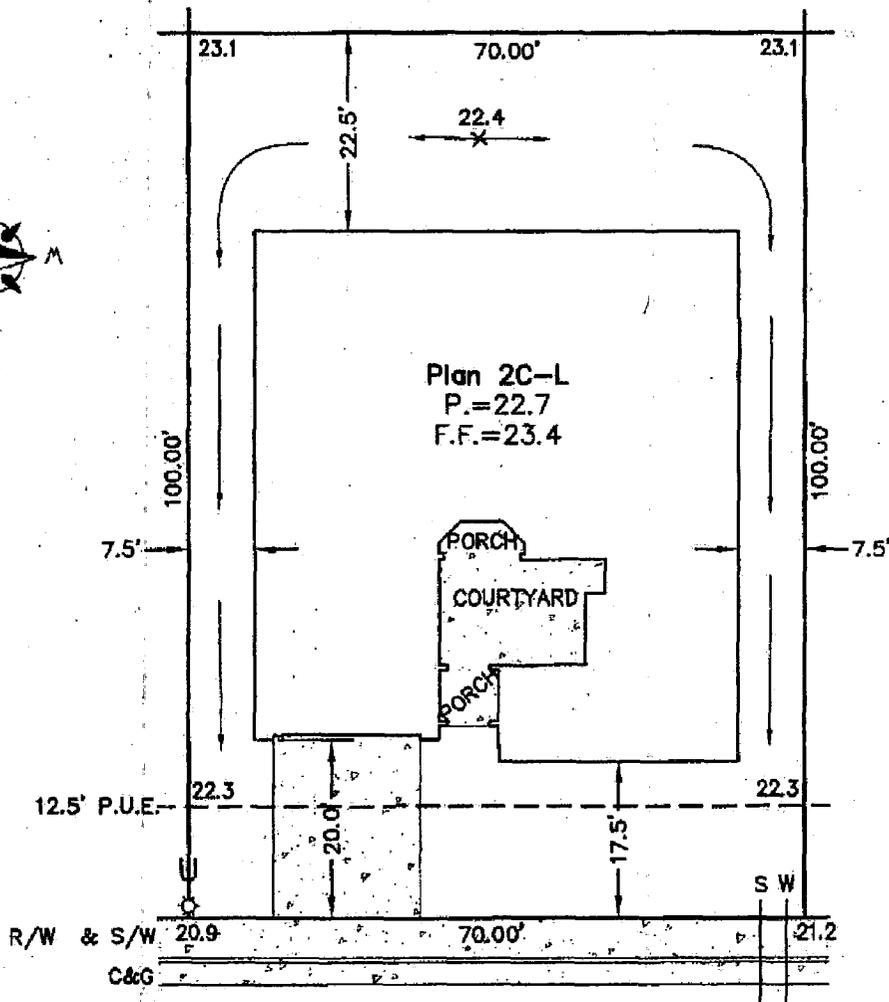NET LOT AREA = 7,000 SQ. FEET
FOOTPRINT AREA = 2,918 SQ. FEET
LOT COVERAGE = 42%

LEGEND

- U - - - - UTILITY LOCATION
- ☒ - - - - AIR CONDITIONER
- S - - - - SEWER
- W - - - - WATER
- ⊙ - - - - STREET LIGHT

SCALE: 1" = 20'




PLOT PLAN LOT 96

Natomas Creek Village 1
Sterling Hills - Phase 1
City of Sacramento, State of California

WECKER SURVEYS

1111 KENNEDY PLACE
SUITE 4
DAVIS, CA 95616
530-792-7252
FAX 530-758-2775

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LEGEND

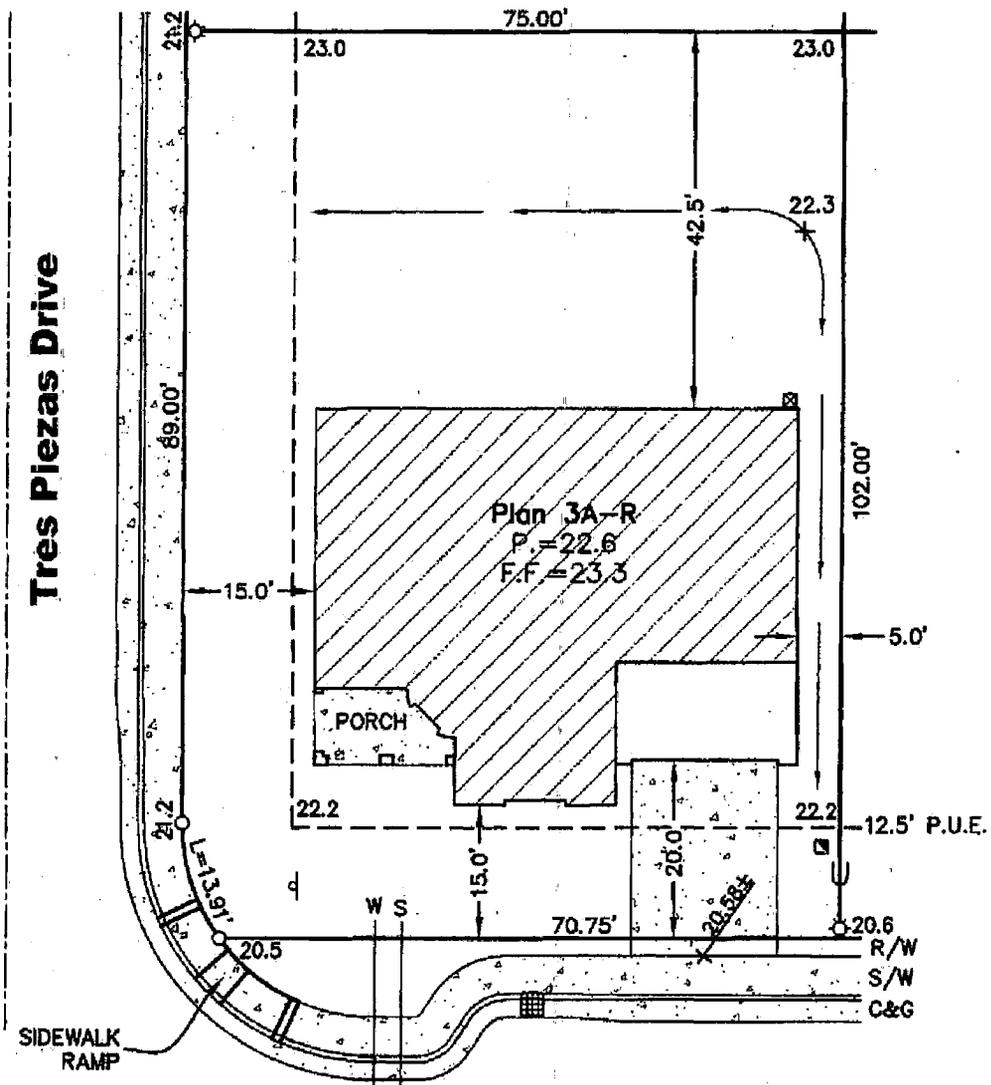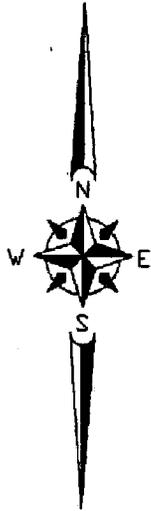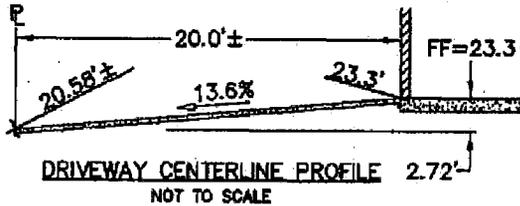- U - - - - UTILITY LOCATION
- ⊗ - - - - AIR CONDITIONER
- S - - - - SEWER
- W - - - - WATER
- O - - - - DIMENSION POINT
- ☆ - - - - STREET LIGHT
- ⊙ - - - - STREET SIGN
- ▨ - - - - DRAIN INLET
- - - - - SUREWEST VAULT

Mike Waldron Drive

NET LOT AREA = 7,632 SQ. FEET
 FOOTPRINT AREA = 2,145 SQ. FEET
 LOT COVERAGE = 28%


SCALE: 1" = 20'

PLOT PLAN
 LOT 1131
 Sterling Hills at Natomas Creek
 City of Sacramento, State of California

**WECKER
 SURVEYS**

1111 KENNEDY PLACE
 SUITE 4
 DAVIS, CA 95616
 530-792-7252
 FAX 530-758-2775

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NET LOT AREA = 7,500 SQ. FEET
FOOTPRINT AREA = 2,145 SQ. FEET
LOT COVERAGE = 29%

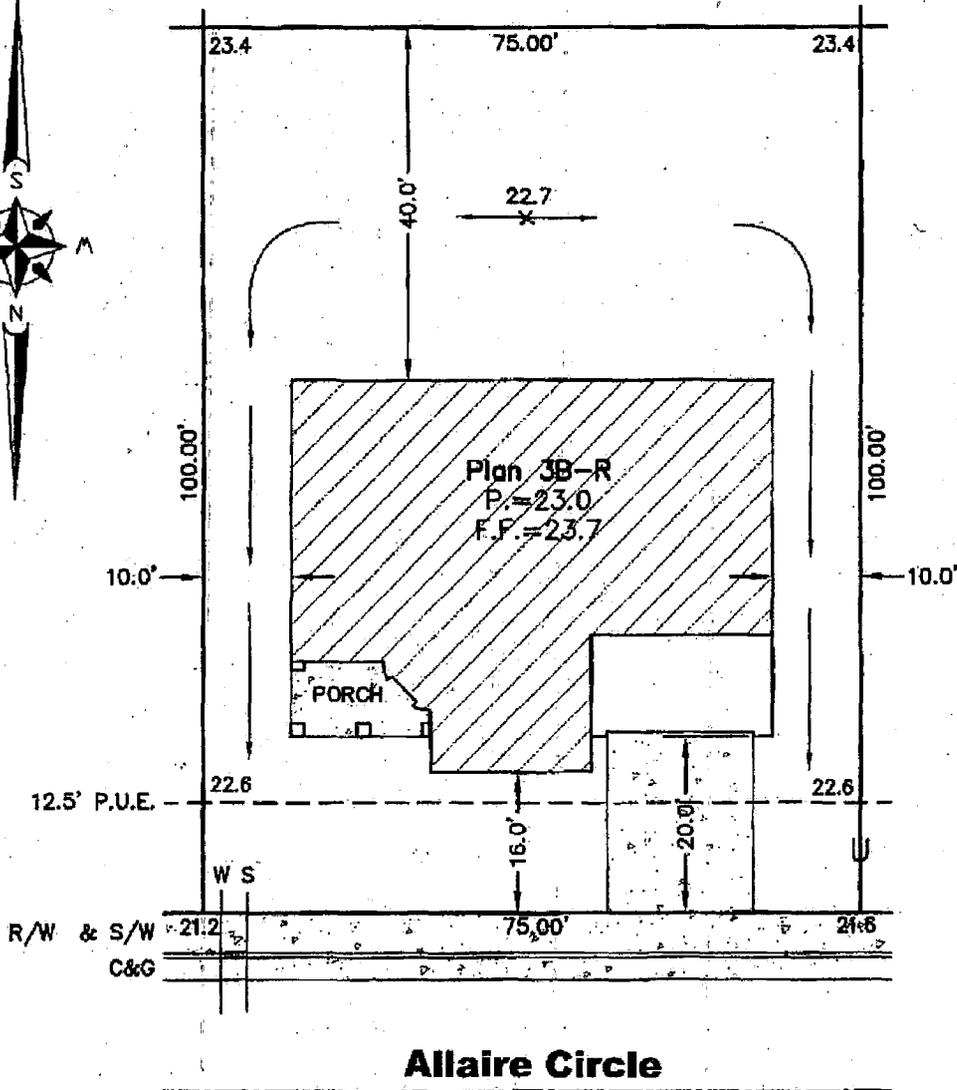LEGEND:

- U - - - - UTILITY LOCATION
- ☒ - - - - AIR CONDITIONER
- S - - - - SEWER
- W - - - - WATER

SCALE: 1" = 20'



**PLOT PLAN
LOT 95**

Natomas Creek Village 1
Sterling Hills - Phase 1
City of Sacramento, State of California

**WECKER
SURVEYS**

1111 KENNEDY PLACE
SUITE 4
DAVIS, CA 95616
530-792-7252
FAX 530-758-2775

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LEGEND

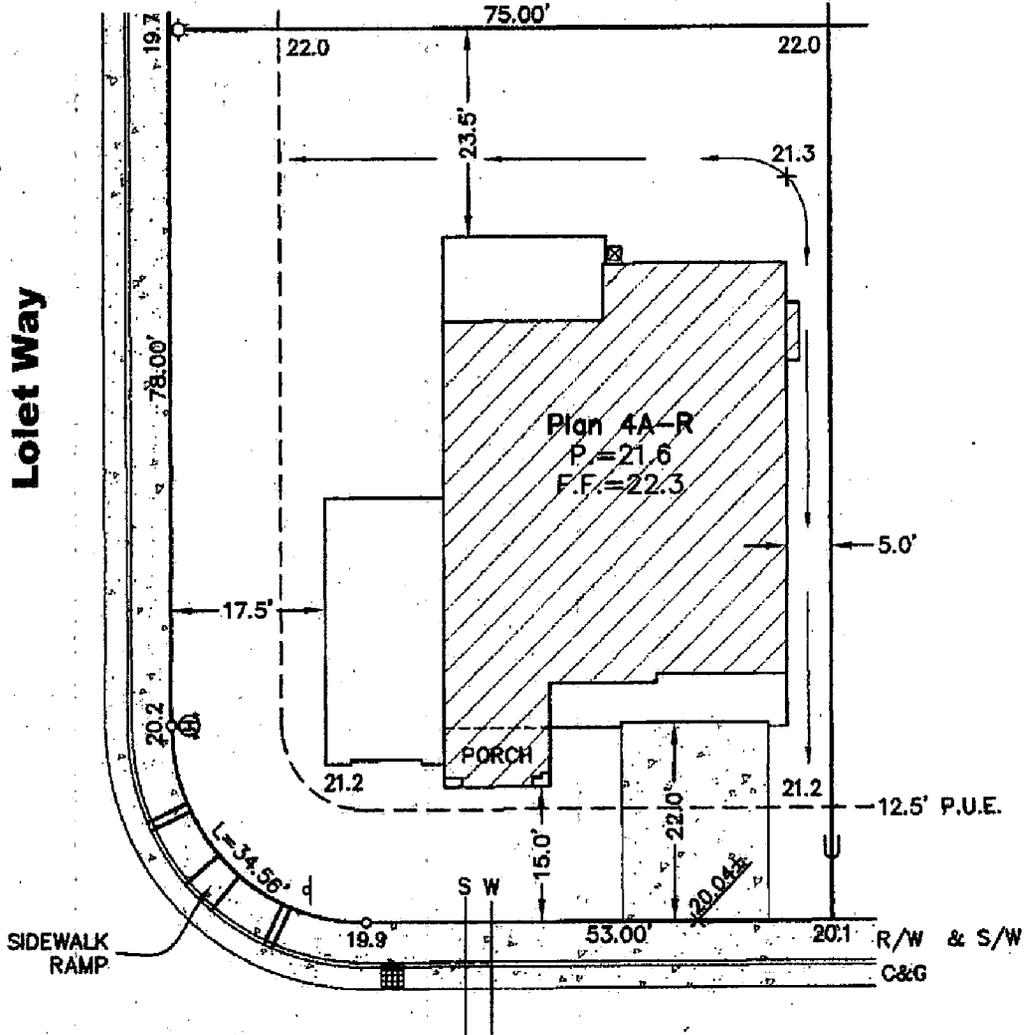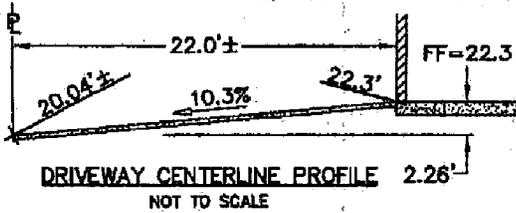- U - - - - UTILITY LOCATION
- ☒ - - - - AIR CONDITIONER
- S - - - - SEWER
- W - - - - WATER
- ▣ - - - - DRAIN INLET
- ⊕ - - - - FIRE HYDRANT
- - - - - DIMENSION POINT
- P - - - - STREET SIGN
- ☆ - - - - STREET LIGHT

Allaire Circle

NET LOT AREA = 7,396 SQ. FEET
FOOTPRINT AREA = 2,472 SQ. FEET
LOT COVERAGE = 33%

SCALE: 1" = 20'


**PLOT PLAN
LOT 1099**
Sterling Hills at Natomas Creek

City of Sacramento, State of California

**WECKER
SURVEYS**

1111 KENNEDY PLACE
SUITE 4
DAVIS, CA 95616
530-792-7252
FAX 530-758-2775

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Allaire Circle

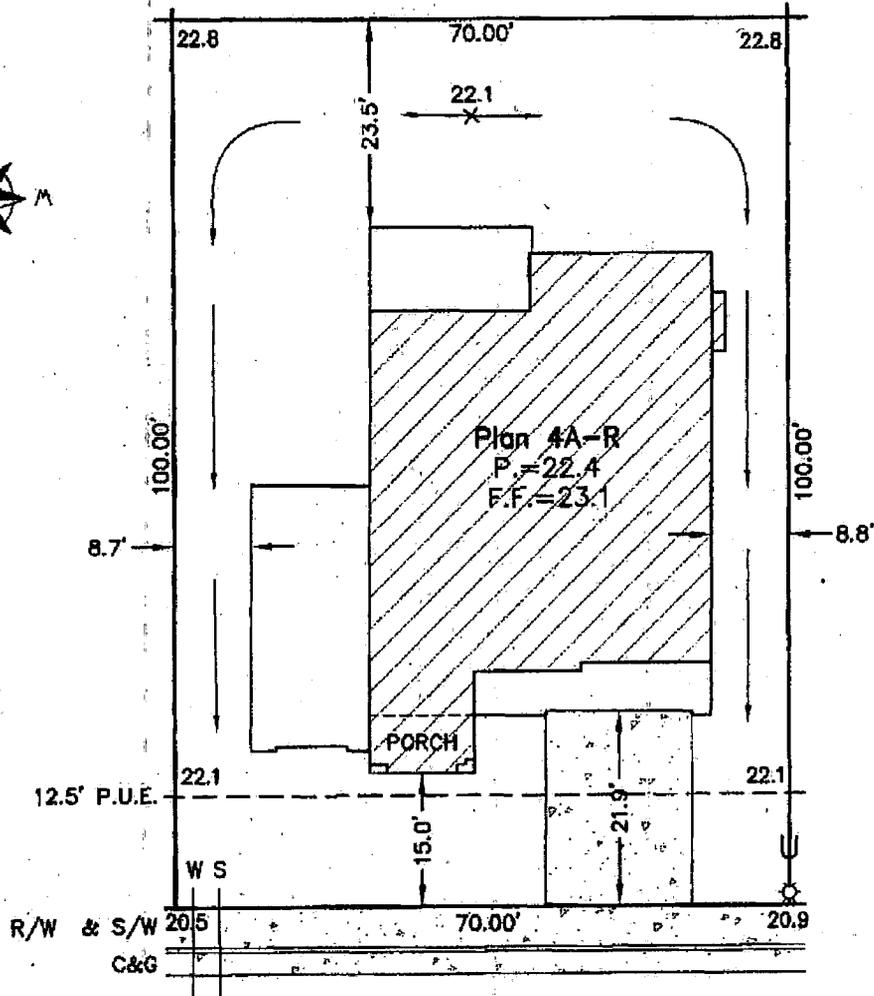NET LOT AREA = 7,000 SQ. FEET
 FOOTPRINT AREA = 2,472 SQ. FEET
 LOT COVERAGE = 35%

LEGEND

- U - - - - UTILITY LOCATION
- ⊗ - - - - AIR CONDITIONER
- S - - - - SEWER
- W - - - - WATER
- ☆ - - - - STREET LIGHT

SCALE: 1" = 20'

PLOT PLAN
LOT 97


Natomas Creek Village 1
Sterling Hills - Phase 1

City of Sacramento, State of California


WECKER SURVEYS

1111 KENNEDY PLACE
 SUITE 4
 DAVIS, CA 95616
 530-792-7252
 FAX 530-758-2775

Exhibit 4: Main Floor Plan
(Plan 1)

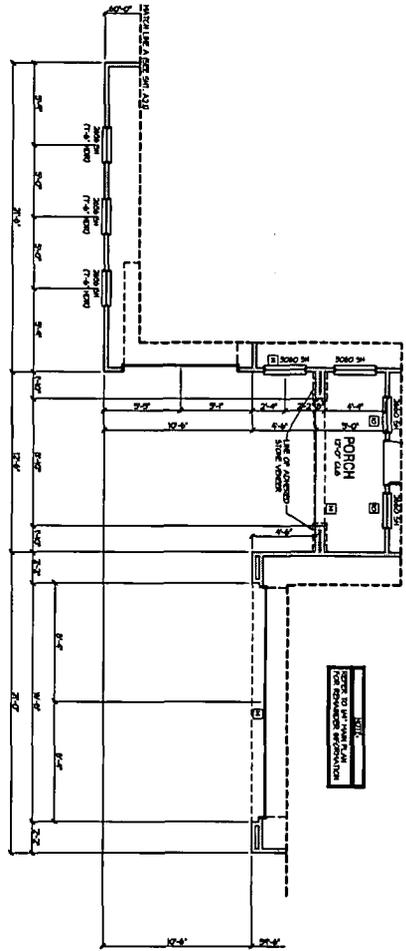

Elevation B
Partial Main Floor Plan

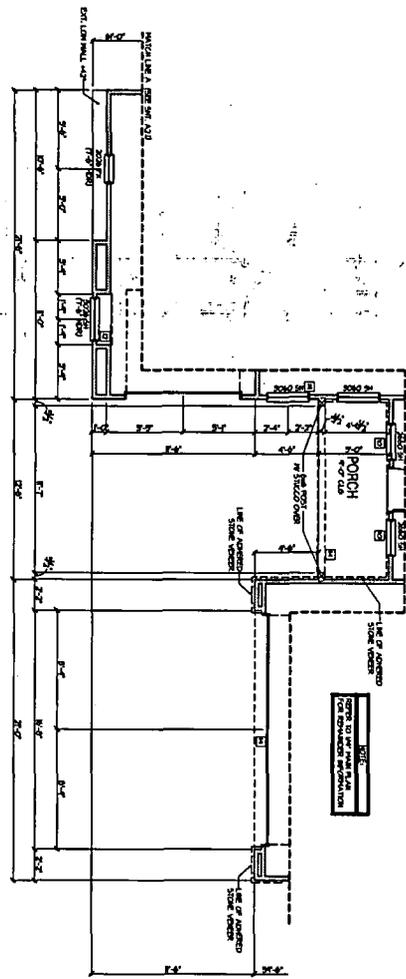


Elevation C
Partial Main Floor Plan

- MAIN FLOOR NOTES**
1. REFER TO GENERAL NOTE SHEET FOR PLAN.
 2. REFER TO SPECIFICATIONS FOR MATERIALS AND FINISHES.
 3. ALL DIMENSIONS UNLESS OTHERWISE NOTED.
 4. FINISHES TO BE AS SHOWN ON FINISH SCHEDULE.
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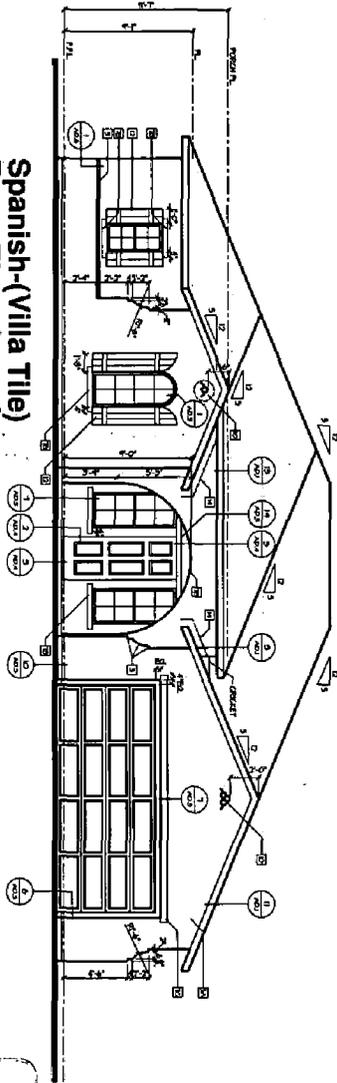
P04-037
Rec'd 3/2/04

<p>NATOMAS CREEK 65 SACRAMENTO, CA</p>		<p>D-R HORTON America's Builder</p>		<p>4401 Hazel Ave. Ste. 225 Fair Oaks, CA 95628 916-965-2200</p>	
<p>117 Woodland Way, Suite 110 Fair Oaks, CA 95628 Phone 916-941-0880</p>		<p>Office Locations</p> <p>•Daly City •Folsom •Fremont •Hayward •Livermore •Oakland •San Francisco •San Jose •Walnut Creek</p>		<p>PERMIT SET</p> <p>1-5-2004</p>	

Exhibit 4: Elevation A
(Plan 1)

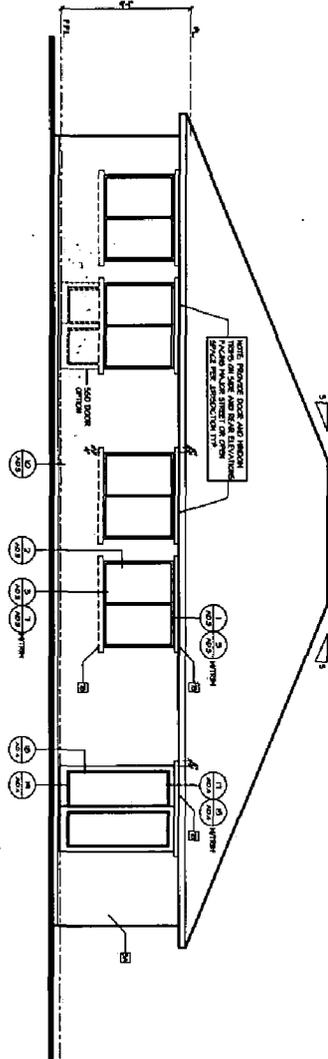

Rear Elevation - A



Spanish-(Villa Tile)
Front Elevation - A

EXTERIOR


ELEVATION NOTES

- 1. EXTERIOR FINISHES SHALL BE AS SHOWN ON THE EXTERIOR ELEVATIONS UNLESS OTHERWISE NOTED.
- 2. EXTERIOR FINISHES SHALL BE AS SHOWN ON THE EXTERIOR ELEVATIONS UNLESS OTHERWISE NOTED.
- 3. EXTERIOR FINISHES SHALL BE AS SHOWN ON THE EXTERIOR ELEVATIONS UNLESS OTHERWISE NOTED.
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- 13. EXTERIOR FINISHES SHALL BE AS SHOWN ON THE EXTERIOR ELEVATIONS UNLESS OTHERWISE NOTED.
- 14. EXTERIOR FINISHES SHALL BE AS SHOWN ON THE EXTERIOR ELEVATIONS UNLESS OTHERWISE NOTED.
- 15. EXTERIOR FINISHES SHALL BE AS SHOWN ON THE EXTERIOR ELEVATIONS UNLESS OTHERWISE NOTED.
- 16. EXTERIOR FINISHES SHALL BE AS SHOWN ON THE EXTERIOR ELEVATIONS UNLESS OTHERWISE NOTED.
- 17. EXTERIOR FINISHES SHALL BE AS SHOWN ON THE EXTERIOR ELEVATIONS UNLESS OTHERWISE NOTED.
- 18. EXTERIOR FINISHES SHALL BE AS SHOWN ON THE EXTERIOR ELEVATIONS UNLESS OTHERWISE NOTED.
- 19. EXTERIOR FINISHES SHALL BE AS SHOWN ON THE EXTERIOR ELEVATIONS UNLESS OTHERWISE NOTED.
- 20. EXTERIOR FINISHES SHALL BE AS SHOWN ON THE EXTERIOR ELEVATIONS UNLESS OTHERWISE NOTED.


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<p>NATOMAS CREEK 65 SACRAMENTO, CA</p>		<p>D-R HORTON America's Builder</p>		<p>4401 Hazel Ave. Ste. 225 Fair Oaks, CA 95628 916-965-2200</p>	
<p>1177 Douglas Way, Suite 110 Sacramento, CA 95833 Phone: 916-941-0880</p>		<p>Office Locations</p> <p>•Coe •Molokai •Yuba •Sacramento •Chicago •Phoenix •Dallas •Corte Madera •Lodi •Stockton •Chico •Humboldt</p>		<p>PERMIT SET</p> <p>DATE: 02/25/2004 8:40 AM</p>	

Rear Elevation - C

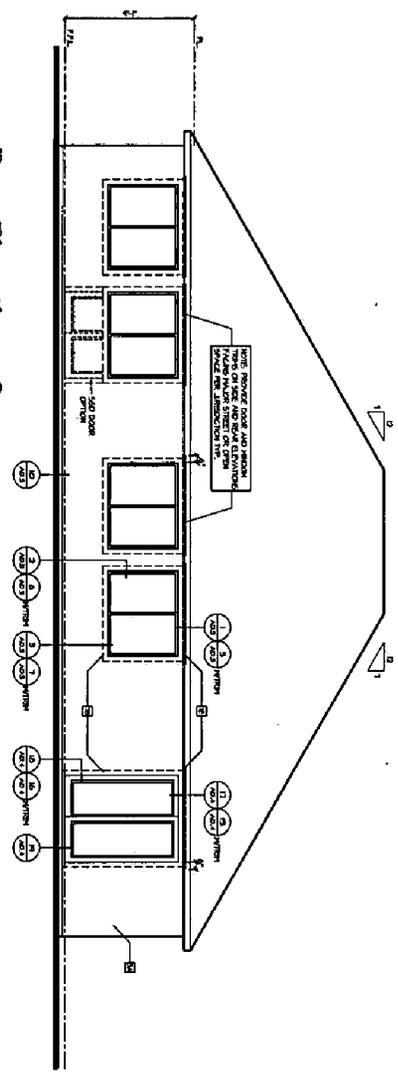

French-(Slate Tile)
Front Elevation - C

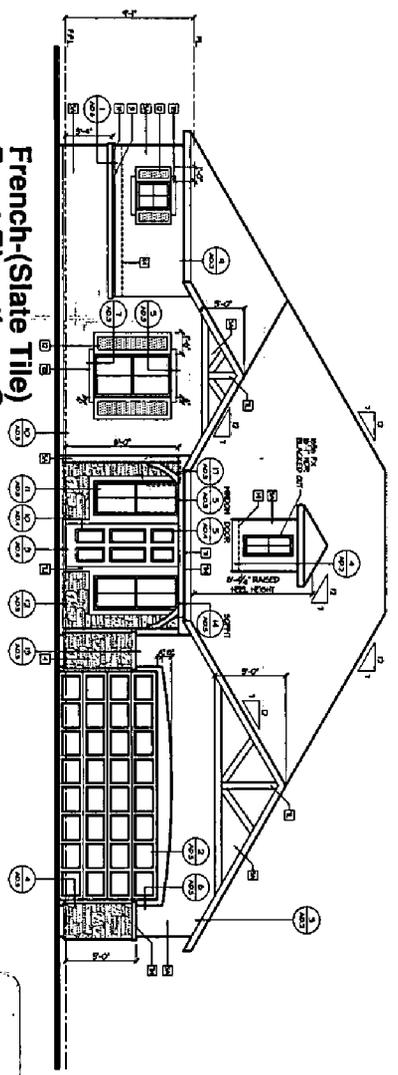


- EXTERIOR ELEVATION NOTES**
- A. FINISH TO BE SHOWN ON ELEVATION DRAWING.
 - B. FINISH TO BE SHOWN ON ELEVATION DRAWING.
 - C. FINISH TO BE SHOWN ON ELEVATION DRAWING.
 - D. FINISH TO BE SHOWN ON ELEVATION DRAWING.
 - E. FINISH TO BE SHOWN ON ELEVATION DRAWING.
 - F. FINISH TO BE SHOWN ON ELEVATION DRAWING.
 - G. FINISH TO BE SHOWN ON ELEVATION DRAWING.
 - H. FINISH TO BE SHOWN ON ELEVATION DRAWING.
 - I. FINISH TO BE SHOWN ON ELEVATION DRAWING.
 - J. FINISH TO BE SHOWN ON ELEVATION DRAWING.
 - K. FINISH TO BE SHOWN ON ELEVATION DRAWING.
 - L. FINISH TO BE SHOWN ON ELEVATION DRAWING.
 - M. FINISH TO BE SHOWN ON ELEVATION DRAWING.
 - N. FINISH TO BE SHOWN ON ELEVATION DRAWING.
 - O. FINISH TO BE SHOWN ON ELEVATION DRAWING.
 - P. FINISH TO BE SHOWN ON ELEVATION DRAWING.
 - Q. FINISH TO BE SHOWN ON ELEVATION DRAWING.
 - R. FINISH TO BE SHOWN ON ELEVATION DRAWING.
 - S. FINISH TO BE SHOWN ON ELEVATION DRAWING.
 - T. FINISH TO BE SHOWN ON ELEVATION DRAWING.
 - U. FINISH TO BE SHOWN ON ELEVATION DRAWING.
 - V. FINISH TO BE SHOWN ON ELEVATION DRAWING.
 - W. FINISH TO BE SHOWN ON ELEVATION DRAWING.
 - X. FINISH TO BE SHOWN ON ELEVATION DRAWING.
 - Y. FINISH TO BE SHOWN ON ELEVATION DRAWING.
 - Z. FINISH TO BE SHOWN ON ELEVATION DRAWING.

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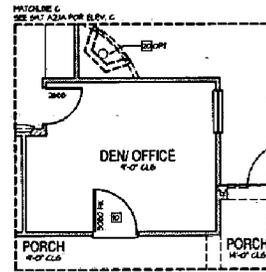
<p>NATOMAS CREEK 65 SACRAMENTO, CA</p>		<p>D-RHORIEN America's Builder</p>		<p>4401 Hazel Ave. Ste. 225 Fair Oaks, CA 95628 916-985-2200</p>	
<p>1177 Westpark Blvd. Suite 110 Sacramento, CA 95834 Phone: 916-981-0889</p>		<p>Office Locations</p> <p>• Colton • Colton</p>		<p>1-5-2004 PERMIT SET</p>	

Exhibit 5: Main Floor Plan
(Plan 2)

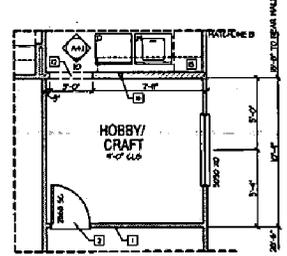


Hobby/ Craft Option
Partial Main Floor Plan

SCALE: 1/4" = 1'-0"



Elevation A & B
Den/ Office Option
Partial Main Floor Plan

SCALE: 1/4" = 1'-0"

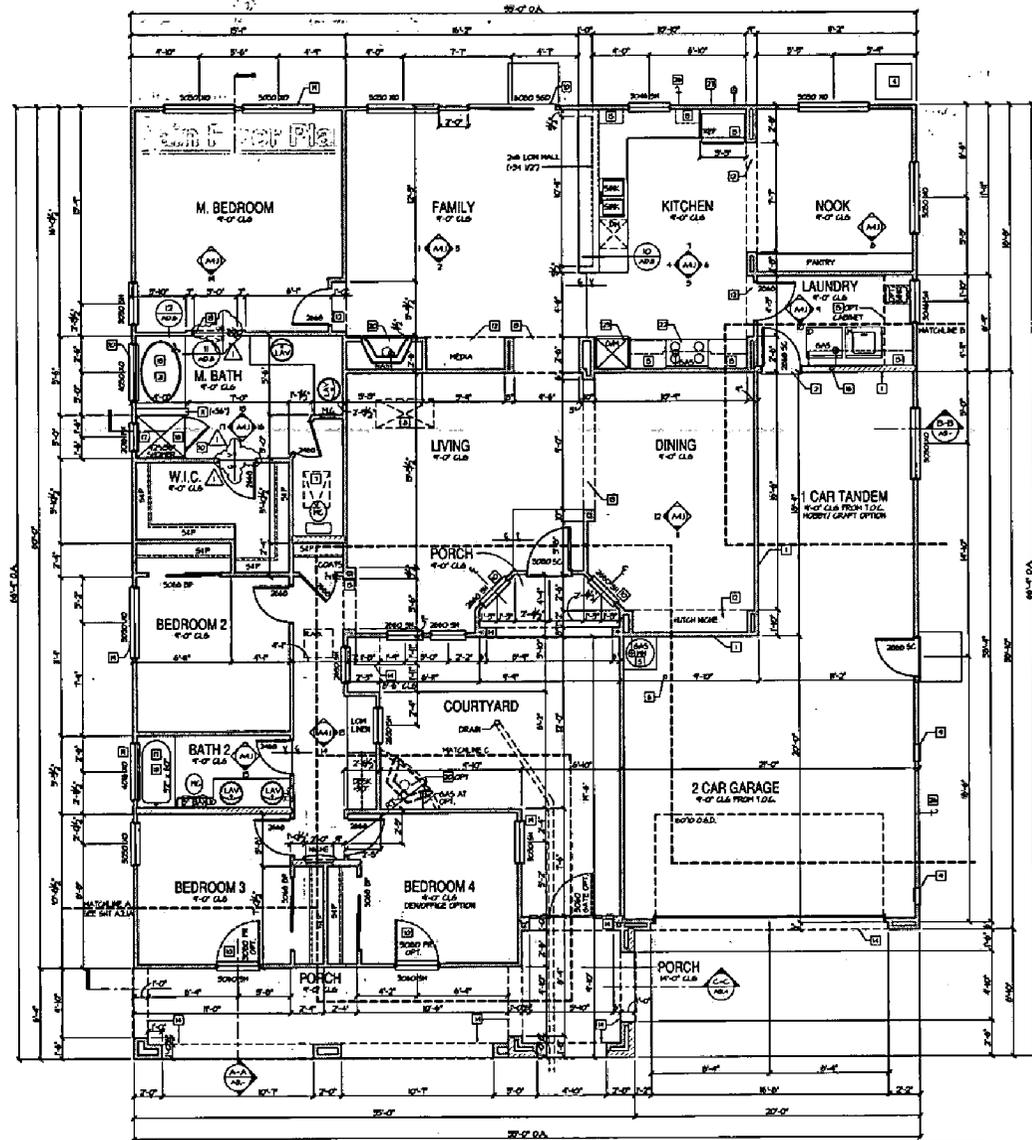

Elevation A
Main Floor Plan

SCALE: 1/4" = 1'-0"

SQUARE FOOTAGES

1st FLOOR	3263
UPPER FLOOR	524
2nd FLOOR	524
Garage	675
TOTAL	5000
1st FLOOR DEN/ OFFICE	115
Garage AT OFFICE	115
OFFICE AT OFFICE	115
Garage Option	115

MAIN FLOOR NOTES

- REVISIONS:**
- A. REFER TO GENERAL NOTE SHEETS FOR PLAN REVISIONS.
 - B. REFER TO DWG SHEETS FOR CERTIFICATE OF COMPLIANCE AND SCHEDULES FOR MATERIALS.
 - C. ALL DIMENSIONS SHALL BE TO FINISH UNLESS NOTED OTHERWISE.
 - D. WINDOW HEAD HEIGHTS: 1ST FLOOR = 8'-0" S.I.D. 2ND FLOOR = 8'-0" S.I.D. DOOR HEIGHTS AS NOTED ON DRAWINGS (ALSO ADJUST WINDOW HEADER HEIGHT WITH DOOR HEADERS)
- DETAILS NOTES:**
- 1. HOME TO GARAGE FIRE SEPARATION: GARAGE/FIRE SEPARATION AT VERTICAL SURFACE SHALL BE PROVIDED WITH ONE (1) LAYER 5/8" TYPE X GYPSUM BOARD PER IBC SEC. 703.4 AND TABLE 7-8. FOR 1'-0". GARAGE/FIRE SEPARATION AT HORIZONTAL SURFACE AS 2" O.C. SHALL BE PROVIDED WITH TWO (2) LAYERS 5/8" TYPE X GYPSUM BOARD PER IBC TABLE 7-8. FOR 2'-0".
 - 2. HOME TO GARAGE DOOR SEPARATION: PROVIDE 1-1/2" SOLID CORE DOOR OR APPROX. 30 MINUTE RATED DOOR WITH SELF CLOSURE AND TRIP FITTING.
 - 3. BATH STAIRS AND LAUNDRY: 3/4" TYPE X SURFING AT 2" O.C. OR HALLS AND LATHS OF ENCLOSED ACCESSIBLE AREA.
 - 4. ALL CONDENSERS OR 30" X 30" MIN PRECAST CONCRETE PAV. 2" THICK ABOVE GRADE. PROVIDE WITH 1" MIN. COVER OF CONCRETE. SEE PER DETAIL. SEE DETAIL MAND AND GENERAL NOTES.
 - 5. HALL AND CORRIDOR FLOORS TO BE STANDARD FLOOR FINISH PER SLAB PERMITTER LAYOUT. SEE DETAIL. LARGE ROOMS TO REMOVE LARGEST PIECE OF EQUIPMENT BUT NOT LESS THAN 30" WIDE. SEE DETAIL. SHOW.
 - 6. FAN IN ATTY. ABOVE. PROVIDE UNOBSTRUCTED PROGRAMMABLE THERM. IN LARGE ROOMS TO REMOVE THE LARGEST PIECE OF EQUIPMENT WITH 30" HIGH X 30" WIDE PROGRAMMABLE WITH 30" HIGH X 30" WIDE PLATFORM WITH 30" X 30" PLATFORM AT SERVICE SIDE OF THE EQUIPMENT. HALL 30" X 30" FROM ACCESS POINT TO FAN.
 - 7. VERIFY LOCATION OF MECHANICAL DRAWINGS. RETAIN FOR GENERAL NOTES.
 - 8. PROVIDE SCHEDULED LARGEST LON. EXPANSION AIR VENTS.
 - 9. ENHANCED SAFETY SLUGS PER GENERAL NOTES SECTION 0500.
 - 10. LON. HALL HEIGHT AS NOTED. IF DOUBLE TOP PLATE, SEE DETAIL. SHOW. (4" FLOOR, 4" AFF. S.I.D.)
 - 11. PLAY SPOTS AT 8' X 8' S.I.D. FRAME DIMENSIONS ARE AS NOTED.
 - 12. INTERIOR FLOORS FRAME DIMENSIONS TYPICAL. PLAY SPOTS IN 12" BAYED CORNERS. SEE DETAIL AND FOR EVALUATION AND DIMENSIONS.
 - 13. EXTERIOR SPOTS OR ARCH FOR EXTERIOR ELEVATION FOR DIMENSIONS.
 - 14. HALL WARDROBE CABINET ABOVE. 2" DEEP UPPER CABINET ABOVE REFRIGERATOR.
 - 15. DRYER: VENT DUCT SHALL BE OF SPECIFIED METAL, EXTENDING TO EXTERIOR WITH BACKUP SUPPORT FOR GAS AND CONDENSATE. HANGERS WITH 120" X 120" DEGREE CLOSURE. SEE PER DETAIL. SEE PER DETAIL.
 - 16. SINKS AND TUBS/SHOWER COMBINATIONS: PROVIDE A SPECTRUM HUNG MANAGEMENT SURFACE OVER HUNG-TUBS/SHOWER SYSTEM. BOARD TO A HEIGHT OF 10" ABOVE ABOVE DRAIN BUILT. DOOR 45" HIGH. (12" PER 6" SLUG ENCLOSURE)
 - 17. PROVIDE REMOVABLE CONTROL VALVES OF THE PRESSURE DRAINAGE OF THE IMPROPER. PRESSURE VALVE TYPE FOR THE BLOWER AND SUBSEQUENT COMBINATION.
 - 18. INHIBITING BARRIER: ONE EACH IN EACH ELECTRIC AREA. SHALL COMPLY WITH BOTH FIRE AND BOLLING CODES. BARRIER HEIGHT SHALL HAVE A NET CLEAR OPENING AREA OF 31" SQUARE FEET. THE FIREMANT NET CLEAR OPENING HEIGHT DIMENSION SHALL BE 34" SQUARE FEET AND THE HEIGHT NET CLEAR OPENING HEIGHT DIMENSION SHALL BE 30" SQUARE FEET. BARRIER HEIGHT SHALL HAVE A PROHIBITED HEIGHT OF NOT MORE THAN 34" HEIGHT ABOVE THE FLOOR.
 - 19. PERMANENT METAL: ALL CORNER VENTS AND FLOORPLATE. SEE SHEET A2.2 FOR ELEVATION DETAIL AND USE SHALL BE IN ACCORDANCE WITH THE MANUFACTURER'S REQUIREMENTS.
 - 20. IF A HOT REFRIGERATOR IS LOCATED THE UPPER SPLASH AND DECK.
 - 21. 3/4" BRASS COVER TO 1/2" MIN. HOLES. LINE, EXPOSED FIN ABOVE. VENT PER GENERAL NOTES SECTION.
 - 22. 3/4" ELECTRIC COVER BY INTERNAL MECHANISM COVER.
 - 23. LINES IN HORIZONTAL. FIVE (5) 1/2" DEEP SLOVES.
 - 24. HANGER DRAIN PAN AT SECOND FLOOR ONLY. DRAIN TO EXTERIOR.
 - 25. EXTERIOR-WALLS: FINISH: PROVIDE WITH NON-REMOVABLE BACKLASH PERMITTER DESIGN.
 - 26. GOLD FINISH 5/8" O.P.
 - 27. SHOWER LINE INDICATES OUTLINE OF UPPER FLOOR ABOVE. SOLID LINE INDICATES OUTLINE OF 1st FLOOR BELOW.



NO.	DATE	DESCRIPTION

4401 Hazel Ave, Ste. 225
Sacramento, CA 95828
Fair 916-962-6200


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America's Builder

NATOMAS CREEK 65
SACRAMENTO, CA

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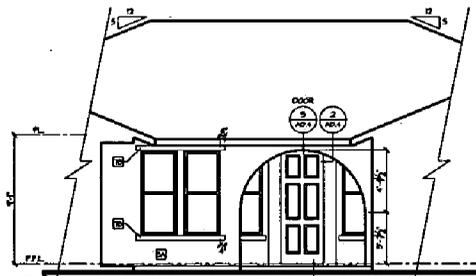
Exhibit 5: Elevation 'A'
(Plan 2)



Rear Elevation - A

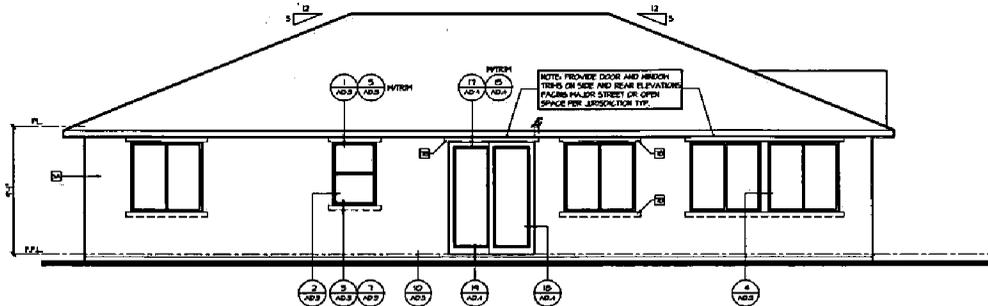
SCALE: 1/4" = 1'-0" H2020-1

NOTE: PROVIDE DOOR AND WINDOW TRIMS ON SIDE AND REAR ELEVATIONS FACING MAJOR STREET OR OPEN SPACE PER JURISDICTION TYPE.




Courtyard - AA
Partial Elevation - A

SCALE: 1/4" = 1'-0" H2020-1

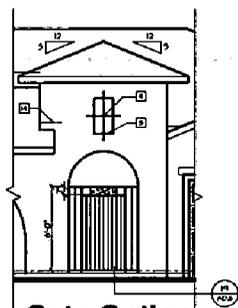

Gate Option
Partial Front Elevation - A

SCALE: 1/4" = 1'-0" H2020-1

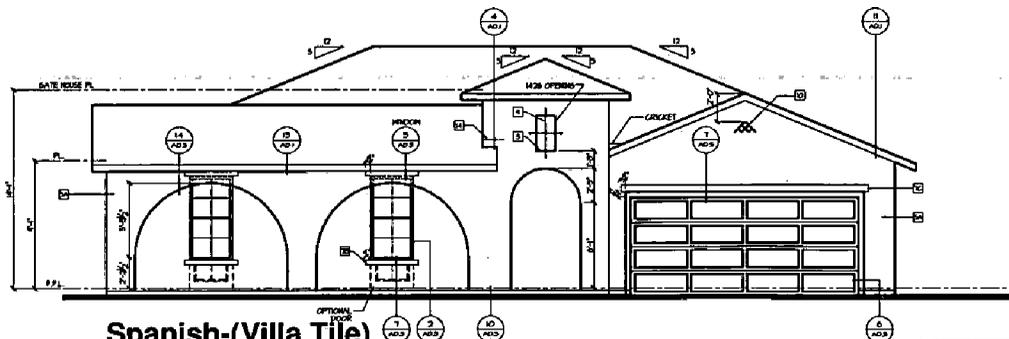

Spanish-(Villa Tile)
Front Elevation - A

SCALE: 1/4" = 1'-0" H2020-1

**EXTERIOR
ELEVATION NOTES**
SEE EXHIBIT

- A. REFER TO GENERAL NOTE SHEETS FOR TYPICAL REQUIREMENTS AND MATERIAL DESCRIPTION OF MATERIALS.
- B. FINISH: ROOF FINISHES:
- 1ST FLOOR: 6" OF G-1/2 ON EXT. ELEVATION
- 2ND FLOOR: 6" OF G-1/2
- DOOR HEIGHTS AS NOTED ON PLANS. ALLOW AN ADJACENT WINDOW HEIGHT NEARBY WITH DOOR HEADRAYS.
- C. EXTERIOR WALLS:
- STICCO SYSTEM OVER 1" FOAM INSULATION PER GENERAL NOTES. CORROSION RESISTANT. KEEP SCRIBED AT BASE.
- D. EXTERIOR SCRIBITS:
- STICCO PER GENERAL NOTES.
- E. ROOFING:
- CLASS 'A' FIRE-RETARDING CONCRETE TILES
- ELEVATION 'A': LOW-PROFILE
- CONCRETE TILE PER GENERAL NOTES. SEE ROOFING DETAILS FOR FLASHINGS.
- ELEVATION 'B': LOW-PROFILE
- CONCRETE TILE PER GENERAL NOTES. SEE ROOFING DETAILS FOR FLASHINGS.
- ELEVATION 'C': PLANT CONCRETE TILE PER GENERAL NOTES. SEE ROOFING DETAILS FOR FLASHINGS.

ELEVATION KEY NOTES

- 1. STICCO RESIN- 2" SCUMMED AS NOTED. SEE DETAILS. EXECUTIVE FINISH (IRON MORTAR SHOW)
- 2. STICCO SHELTER FLOW MALL. STICCO OVER ELASTOMERIC FLASHING. SEE EXTERIOR ELEVATIONS FOR DETAIL.
- 3. SLOPING SURFACE. STICCO OVER ELASTOMERIC FLASHING. SEE DETAIL S-TANDA.
- 4. LOWERED STONE VENEER AS SELECTED BY BUILDER. HEIGHT AS NOTED. SEE DETAIL.
- A. STICCO 4" TYP.
- B. STICCO 1" TYP.
- 5. LOWERED STONE VENEER TRIM. SEE DETAIL.
- 6. STICCO OVER FOAM TRIM:
A. 1/2" FOAM IN STICCO OVER.
B. 1/4" FOAM IN STICCO OVER.
C. 3/8" FOAM IN STICCO OVER.
D. 1/2" FOAM IN STICCO OVER.
E. 3/4" FOAM IN STICCO OVER.
F. 1" FOAM IN STICCO OVER.
G. 1 1/4" FOAM IN STICCO OVER.
H. 1 3/4" FOAM IN STICCO OVER.
I. 2" FOAM IN STICCO OVER.
J. 2 1/2" FOAM IN STICCO OVER.
K. 3" FOAM IN STICCO OVER.
L. 3 1/2" FOAM IN STICCO OVER.
- 7. SCRIBED STICCO 4" TYP.
- 8. DECORATIVE MOUNTAIN RAIL. SEE DETAILS.
- 9. 1/2" HALF ROUND - 1" DEEP PLUNGED MOUNTED DECORATIVE GLAZ PIPES. SEE ELEVATIONS AND DETAIL S-TANDA.
- 10. CORROSION RESISTANT SCREEN LOWERED 1/2" FROM MAJOR. SEE EXTERIOR ELEVATION FOR DETAILS.
- 11. FALSE WOOD MATERIAL. TYPE AS SHOWN. SEE DETAILS S-TANDA.
- 12. LOWERED FINISH. SEE DETAIL S-TANDA.
- 13. CORROSION RESISTANT ROOF TO MALL FLASHING. SEE ROOF DETAILS.

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America's Builder

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Fair Oaks, CA 95628
Tel: 916-985-1200

NATOMAS CREEK 65
SACRAMENTO, CA

Office Location: _____
Sales Office: _____
Design Office: _____
Production Office: _____

Project No: _____
Drawing No: _____
Scale: _____
Date: _____


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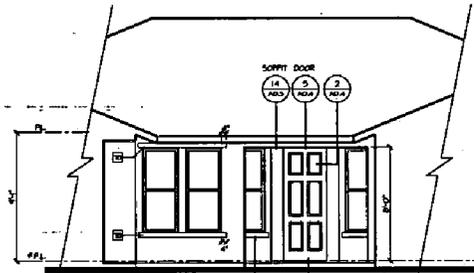
Rec'd 3/2/04

DATE: 03/02/04	SCALE: 1/4" = 1'-0"	PROJECT: NATOMAS CREEK 65	CLIENT: HOODGOOD SHARP
DESIGNER: _____	CHECKED: _____	DATE: 03/02/04	SCALE: 1/4" = 1'-0"
PLAN 2			
BY: _____	DATE: _____	SCALE: _____	PROJECT: _____
BEST TITLE EXTERIOR ARCHITECTURE ELEVATION DRAWING			SHEET A3.1


Exhibit 5: Elevation B
(Plan 2)




Rear Elevation - B
SCALE: 1/4"=1'-0" REF: 2004-3

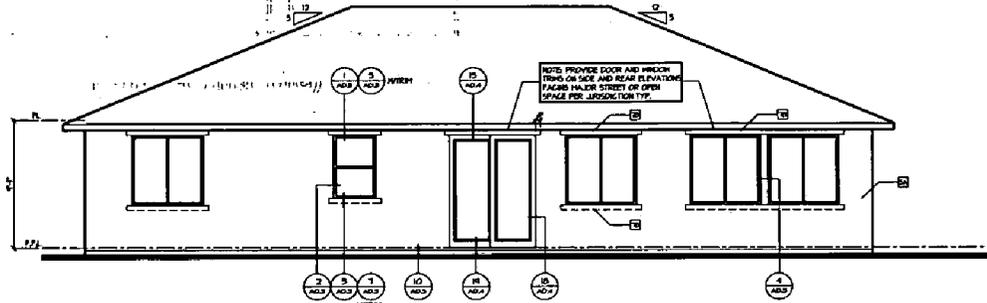

**Courtyard - AA
Partial Front Elevation - B**
SCALE: 1/4"=1'-0" REF: 2004-3

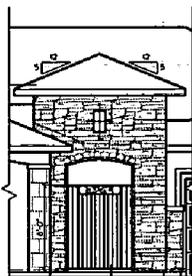

**Gate Option
Partial Front Elevation - B**
SCALE: 1/4"=1'-0" REF: 2004-3

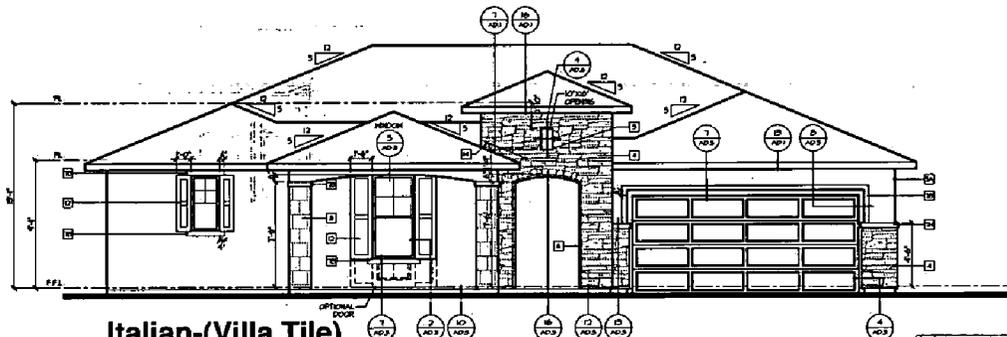

**Italian-(Villa Tile)
Front Elevation - B**
SCALE: 1/4"=1'-0" REF: 2004-3

**EXTERIOR
ELEVATION NOTES**
(NOTES 1-10)

- A. REFER TO GENERAL NOTE SHEETS FOR TYPICAL REQUIREMENTS AND SPECIFIC DESCRIPTION OF MATERIALS.
- B. WINDOW HEADS HEIGHTS:
-1ST FLOOR - 8'-0" UNL. ON EXT. ELEVATIONS
-2ND FLOOR - 9'-0" UNL. UNL. ON INT. PLANS
(ALSO ADJUSTED WINDOW HEADS HEIGHT WITH DOOR HEADS)
- C. EXTERIOR WALLS:
-STUCCO SYSTEM OVER F.F. FROM INSULATION PER GENERAL NOTES. CORROSION RESISTANT KEEP SEALED AT BASE.
- D. EXTERIOR SCOFFS:
-STUCCO PER GENERAL NOTES
- E. ROOFING:
GLASS: 3/4" FIRE-RESISTANT CONCRETE TILE. ELEVATION 10. LOW-PITCHED.
CONCRETE TILE PER GENERAL NOTES. SEE ROOFING DETAILS FOR FLASHING.
ELEVATION 11. LOW-PITCHED.
CONCRETE TILE PER GENERAL NOTES. SEE ROOFING DETAILS FOR FLASHING.
ELEVATION 12. FLAT CONCRETE TILE PER GENERAL NOTES. SEE ROOFING DETAILS FOR FLASHING.

ELEVATION KEY NOTES

- 1 STUCCO FINISH - 3/8" THICK. SEE DETAIL. DECORATIVE MOUNTAIN BROWN HERE SHOWN.
- 2 STUCCO SHIELD / LIN. WALL. STUCCO OVER ELASTOMERIC FLASHING. SEE EXTERIOR ELEVATIONS FOR DETAIL.
- 3 STUCCO SURFACE. STUCCO OVER ELASTOMERIC FLASHING. SEE DETAIL: 5-10-04.
- 4 ADHERED STONE VENEER AS SELECTED BY BUILDER. HEIGHT AS NOTED. SEE DETAIL.
- 5 STUCCO OF TYP. B. STUCCO OF TYP. SEE DETAIL.
- 6 ADHERED STONE VENEER TYP. SEE DETAIL.
- 7 STUCCO OVER FOAM IRON:
A. 1/2" FOAM IN STUCCO OVER
B. 1/2" FOAM IN STUCCO OVER
C. 1/2" FOAM IN STUCCO OVER
D. 1/2" FOAM IN STUCCO OVER
E. 1/2" FOAM IN STUCCO OVER
F. 1/2" FOAM IN STUCCO OVER
G. 1/2" FOAM IN STUCCO OVER
H. 1/2" FOAM IN STUCCO OVER
I. 1/2" FOAM IN STUCCO OVER
J. 1/2" FOAM IN STUCCO OVER
K. 1/2" FOAM IN STUCCO OVER
L. 1/2" FOAM IN STUCCO OVER
M. SHAPED FOAM IN STUCCO OVER
- 8 SCORED STUCCO - 1/4"
- 9 DECORATIVE MOUNTAIN BROWN. SEE DETAIL.
- 10 1/2" HALF ROUND - 1" DEEP PL WOOD MOUNTED. DECORATIVE GLAZED PIPE. SEE ELEVATIONS AND DETAIL: 5-10-04. CORROSION RESISTANT. SCRATCH LOWEST VENT 1/2" UNL. SEE EXTERIOR ELEVATION FOR DETAILS.
- 11 FALSE HEAD SHUTTERS. TYPE AS SHOWN. SEE DETAIL: 5-10-04.
- 12 LOWERED ANNING. SEE DETAIL: 5-10-04.
- 13 CORROSION RESISTANT ROOF TO HALL FLASHING. SEE ROOF DETAIL.



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DR. HORN
America's Builder

NATOMAS CREEK 65
SACRAMENTO, CA


110 Westgate Way, Suite 110
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Phone: 318-985-2200
Fax: 318-985-2200

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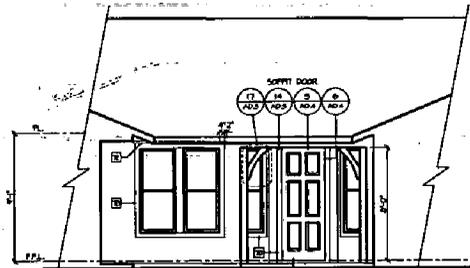
PERMIT SET

Exhibit 5: Elevation C
(Plan 2)




Rear Elevation - C

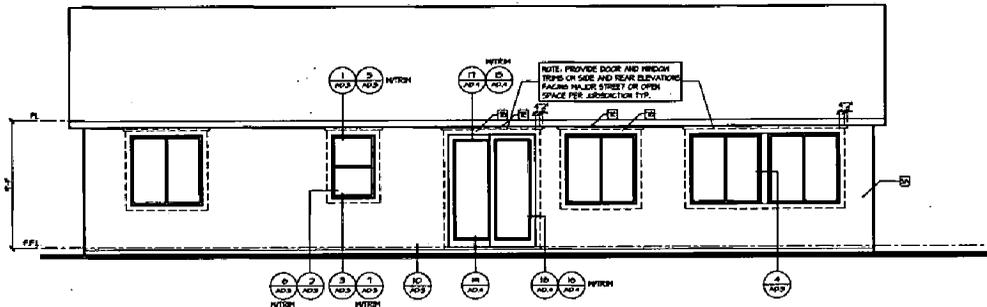SCALE: 1/4"=1'-0" DRAWING NO: 04-037




Courtyard - AA
Partia Elevation - C

SCALE: 1/4"=1'-0" DRAWING NO: 04-037

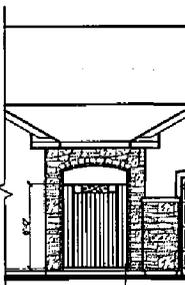

Gate Option
Partial Front Elevation - C

SCALE: 1/4"=1'-0" DRAWING NO: 04-037

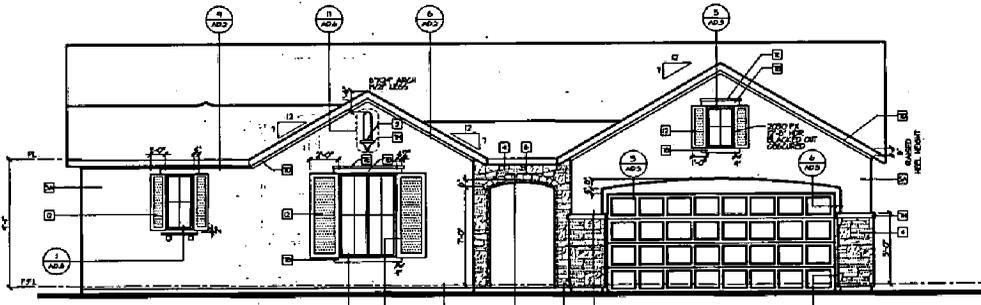

French-(Flat Tile)
Front Elevation - C

SCALE: 1/4"=1'-0" DRAWING NO: 04-037

**EXTERIOR
ELEVATION NOTES**

- (SEE LISTING)
- REFER TO GENERAL NOTE SHEETS FOR TYPICAL REQUIREMENTS AND SPECIFIC DESCRIPTION OF MATERIALS.
 - WINDOW HEAD HEIGHTS:
 - 1ST FLOOR = 8'-0" WILD OR EXT. ELEVATIONS
 - 2ND FLOOR = 9'-0" WILD
 - DOOR HEIGHTS AS NOTED ON PLANS, (ALSO ADJACENT WINDOW HEADS/HEADS WITH DOOR HEADERS).
 - EXTERIOR WALLS:
 - STRENGTH SYSTEM OVER F.P. FROM INSULATION PER GENERAL NOTES, CORROSION RESISTANT FEET SCREENS AT BASE.
 - STRENGTH PER GENERAL NOTES.
 - ROOFING:
 - CLASS 1A FIRE-RETARDANT CONCRETE TILES.
 - ELEVATION KEY NOTES:
 - CONCRETE TILE PER GENERAL NOTES. SEE ROOFING DETAILS FOR FINISHES.
 - ELEVATION 10: LOW-PROFILE CONCRETE TILE PER GENERAL NOTES. SEE ROOFING DETAILS FOR FINISHES.
 - ELEVATION 11: FLAT CONCRETE TILE PER GENERAL NOTES. SEE ROOFING DETAILS FOR FINISHES.
- ELEVATION KEY NOTES:**
- STREGG (REG 8.5")-OF ROOM SIZE AS NOTED. SEE DETAILS. DECORATIVE HORIZONTAL RIBS WHERE SHOWN.
 - STREGG (REG 11")-LOW WALL. STREGG OVER ELASTOMERIC FLASHING. SEE EXTERIOR ELEVATIONS FOR DETAIL.
 - SLOPING SURFACE. STREGG OVER ELASTOMERIC FLASHING. SEE DETAIL. L.V.P.B.
 - ADHERED STONE VENEER AS SELECTED BY BUILDER. HEIGHT AS NOTED. SEE DETAIL.
 - 0.5 STREGG 12" TYP.
 - ADHERED STONE VENEER 12" HIGH. SEE DETAIL.
 - STREGG OVER ROOM TRIM:
 - A. 1/2" FROM IN STREGG OVER
 - B. 3/4" FROM IN STREGG OVER
 - C. 1" FROM IN STREGG OVER
 - D. 1 1/2" FROM IN STREGG OVER
 - E. 2" FROM IN STREGG OVER
 - F. 2 1/2" FROM IN STREGG OVER
 - G. 3" FROM IN STREGG OVER
 - H. 3 1/2" FROM IN STREGG OVER
 - I. 4" FROM IN STREGG OVER
 - J. 5" FROM IN STREGG OVER
 - K. 6" FROM IN STREGG OVER
 - L. 7" FROM IN STREGG OVER
 - M. 8" FROM IN STREGG OVER
 - N. SAWED FROM IN STREGG OVER
 - SCORED STREGG 4".
 - DECORATIVE HORIZONTAL RIBS. SEE DETAILS.
 - 6" HALF ROUND x 1/4" DEEP PLWOOD MOUNTED. DECORATIVE GLAZY FINES. SEE ELEVATIONS AND DETAIL. BEND.
 - CORROSION RESISTANT SCREEN. LOWERED VIEW HEIGHT UNDER. SEE EXTERIOR ELEVATIONS FOR DETAILS.
 - FALSE HOOD BATTERIES. TYPE AS SHOWN. SEE DETAILS 3-UNION.
 - LOWERED FINISH. SEE DETAIL. SWAD.
 - CORROSION RESISTANT FLOOR TO WALL FLASHING. SEE ROOF DETAILS.



DATE	
BY	
CHECKED	
SCALE	
PROJECT	
NO.	
SHEET	
TOTAL SHEETS	

4401 Hazel Ave., Ste. 225
Folsom, CA 95628
916-985-2800

D. HORIUCHI
ARCHITECT
America's Builders


NATOMAS CREEK 65
SACRAMENTO, CA
717 HANCOCK ST. SUITE 111
FOLSOM, CA 95630
Name: 916-985-2800

DATE	11/21/05
BY	D. HORIUCHI
CHECKED	D. HORIUCHI
SCALE	
PROJECT	
NO.	
SHEET	A3.9
TOTAL SHEETS	11

P04-037
Rec'd 3/2/04

1-5-2004

Exhibit 5: Elevation C
(Plan 2)

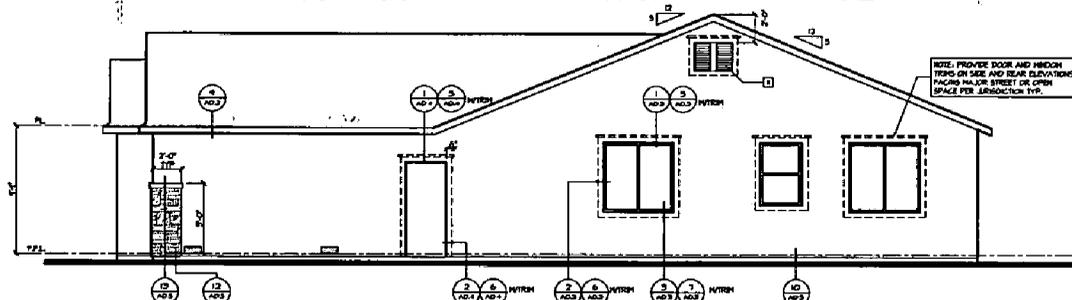

Right Elevation - C

SCALE: 1/4"=1'-0" 1/8"=1'-0"




**Courtyard - BB
Partial Side Elevation - C**

SCALE: 1/4"=1'-0" 1/8"=1'-0"



**Courtyard - BB - Option
Partial Side Elevation - C**

SCALE: 1/4"=1'-0" 1/8"=1'-0"

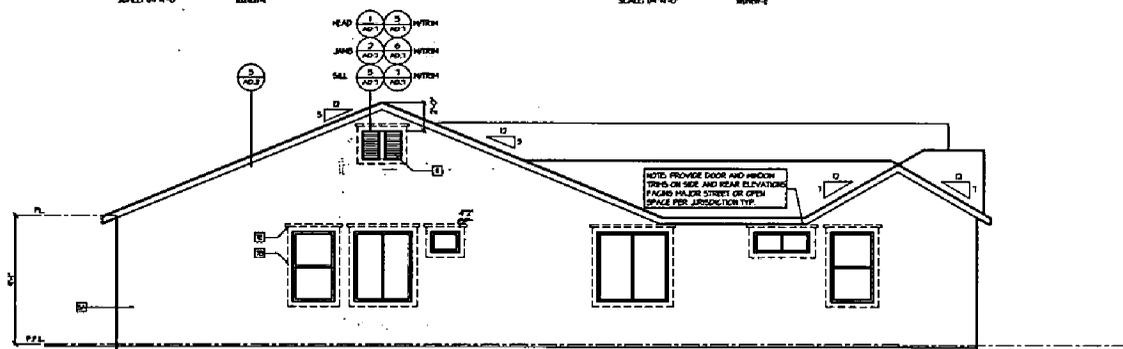

Left Elevation - C

SCALE: 1/4"=1'-0" 1/8"=1'-0"

- EXTERIOR ELEVATION NOTES**
NOTE: EXHIBIT
- REFER TO GENERAL NOTE SHEETS FOR TYPICAL REQUIREMENTS AND SPECIFIC DESCRIPTION OF MATERIALS.
 - WINDOW HEADS: 1ST FLOOR = 8'-0" U.A.D. ON EXT. ELEVATION. 2ND FLOOR = 8'-0" U.A.D. DOOR HEADS AS NOTED ON PLAN. (ALSO ADJUSTMENT WINDOW HEADS 18" MIN WITH DOOR HEADERS)
 - EXTERIOR WALLS: -STUCCO SYSTEM OVER 1" FOAM INSULATION PER GENERAL NOTES. CORROSION RESISTANT KEYS SCHEDULE AS SHOWN.
 - EXTERIOR SOFFITS: -STUCCO PER GENERAL NOTES.
 - ROOFING: -GLAZED TILE FIRE-RETARDANT CONCRETE TILE. ELEVATION "A": LOW PROFILE. CONCRETE TILE PER GENERAL NOTES. SEE ROOFING DETAILS FOR FINISHES. ELEVATION "B": LOW PROFILE. CONCRETE TILE PER GENERAL NOTES. SEE ROOFING DETAILS FOR FINISHES. ELEVATION "C": FLAT CONCRETE TILE PER GENERAL NOTES. SEE ROOFING DETAILS FOR FINISHES.

ELEVATION KEY NOTES

- STUCCO RECESS - 3" WIDTH AS NOTED. SEE DETAILS. DECORATIVE IRONWORK WHERE SHOWN.
- STUCCO SILL / LINI WALL: STUCCO OVER ELASTOMERIC FLASHING. SEE EXTERIOR ELEVATIONS FOR DETAIL.
- FLASHING SURFACE: STUCCO OVER ELASTOMERIC FLASHING. SEE DETAIL. U.A.D.A.
- ADHERED STONE VENEER AS SELECTED BY BIDDER. HEIGHT AS NOTED. SEE DETAIL. A. STUCCO 2" TYP. B. STUCCO 2" TYP.
- ADHERED STONE VENEER TRIM. SEE DETAIL.
- STUCCO OVER ROOF TRIM: A. 1/2" FOAM IN STUCCO OVER B. 1/2" FOAM IN STUCCO OVER C. 1/2" FOAM IN STUCCO OVER D. 1/2" FOAM IN STUCCO OVER E. 1/2" FOAM IN STUCCO OVER F. 1/2" FOAM IN STUCCO OVER G. 1/2" FOAM IN STUCCO OVER H. 1/2" FOAM IN STUCCO OVER I. 1/2" FOAM IN STUCCO OVER J. 1/2" FOAM IN STUCCO OVER K. 1/2" FOAM IN STUCCO OVER L. 1/2" FOAM IN STUCCO OVER M. SHAPED FOAM IN STUCCO OVER.
- SCORED STUCCO UP.
- DECORATIVE IRONWORK. SEE DETAILS.
- DECORATIVE IRONWORK. SEE DETAILS.
- DECORATIVE GLASS PANELS. SEE ELEVATIONS AND DETAIL. S.A.D. 1.
- CORROSION RESISTANT SCREEN LOUVERED VENT. HEIGHT AS NOTED. SEE EXTERIOR ELEVATION FOR DETAILS.
- FALSE WOOD SHUTTERS. TYPE AS SHOWN. SEE DETAILS. S.A.D. 1.
- LOWERED ANHLS. SEE DETAIL. S.A.D. 1.
- CORROSION RESISTANT ROOF TO WALL FLASHING. SEE ROOF DETAILS.



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Fair Oaks, CA 95628
916-966-2200


D. R. HOKIN
America's Builder

NATOMAS CREEK 65
SACRAMENTO, CA


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DRAWN BY: [Name]
CHECKED BY: [Name]
SCALE: 1/4"=1'-0"
SHEET NO. 1 OF 1
PROJECT NO. P04-037

P04-037
Rec'd 3/2/04

Exhibit 6: Main Floor Plan
(Plan 3)

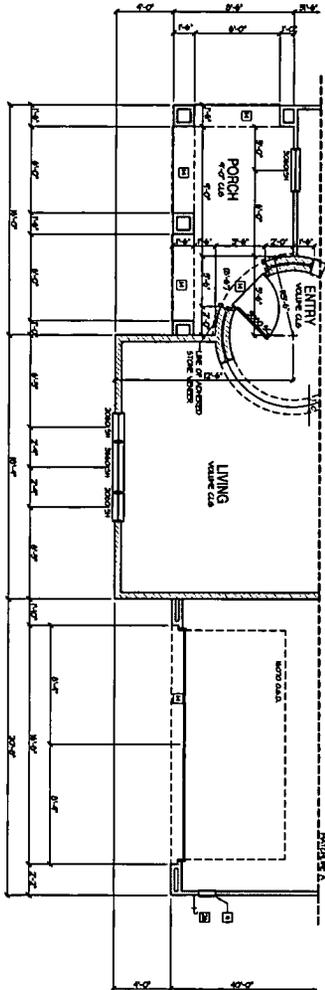

Elevation B
Partial Main Floor Plan

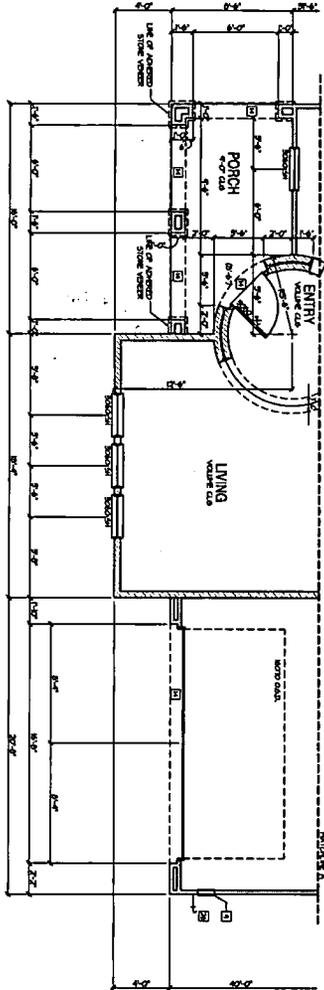


Elevation C
Partial Main Floor Plan

- MAIN FLOOR NOTES**
- A. REFER TO GENERAL NOTE SHEETS FOR PLAN
 - B. REFER TO THE GENERAL NOTE SHEETS FOR PLAN
 - C. ALL DIMENSIONS SHALL BE IN FEET AND INCHES
 - D. FINISH FLOOR TO FINISH FLOOR
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<p>P04-037 Rec'd 3/2/04</p>	<p>NATOMAS CREEK 65 SACRAMENTO, CA</p>	<p>D-R HORTON America's Builder</p>	<p>4401 Hazel Ave. Ste. 225 Fair Oaks, CA 95628 916-965-2200</p>
<p>1-5-2004</p>	<p>PERMIT SET</p>	<p>Office Locations</p> <p>•One Valley •Tempe •Sacramento •Chicago •Phoenix •Dallas •Columbus •Indianapolis •Atlanta •Boston</p>	<p>1117 Woodland Way, Suite 110 D Oroville, CA 95966 Phone: 916-965-2200</p>



ELEVATION A
UPPER FLOOR PLAN

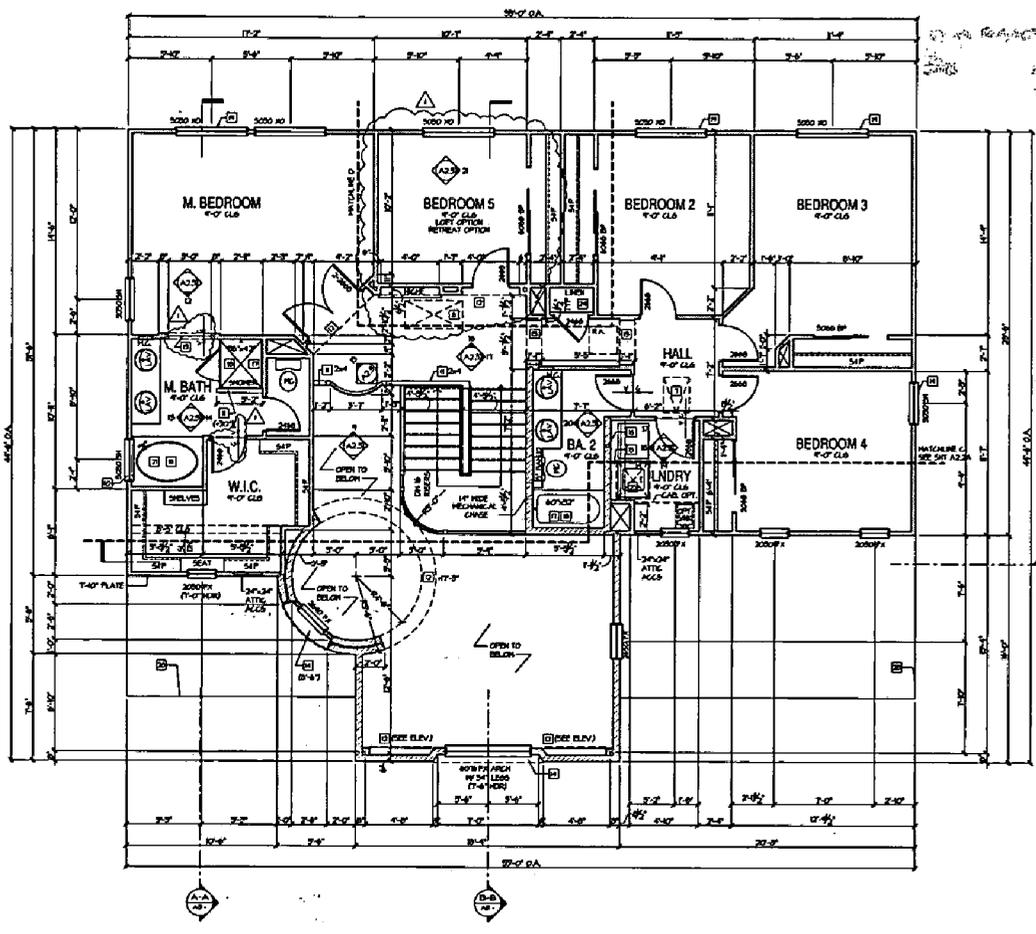

Elevation A
Upper Floor Plan
SCALE: 1/4" = 1'-0"

MAIN FLOOR NOTES

- A. REFER TO GENERAL NOTE SHEETS FOR PLAN GENERAL NOTES.
- B. REFER TO THE SHEETS FOR CERTIFICATE OF COMPLIANCE AND INSURANCE NOTES.
- C. ALL DIMENSIONS SHALL BE TO FACE UNLESS NOTED OTHERWISE.
- D. APPROX. TYPICAL HEIGHTS:
- 1ST FLOOR: 8'-0" FIN.
- 2ND FLOOR: 8'-0" FIN.
- DOOR HEIGHTS AS NOTED ON PLANS (ALSO ALLOWANCE FROM FLOOR HEIGHT TO DOOR HEADS)


FINISHES NOTES

1. REFER TO GENERAL FINISH SCHEDULE.
2. FINISHES TO BE PROVIDED AT VERTICAL SURFACES SHALL BE PROTECTED WITH ONE (1) LAYER 5/8" TYPE 'X' GYPSUM BOARD PER IBC 903.2.2(2) AND TABLE 903.2.2(1).
3. FINISHES TO BE PROVIDED AT HORIZONTAL SURFACES SHALL BE PROTECTED WITH TWO (2) LAYERS 5/8" TYPE 'X' GYPSUM BOARD PER IBC TABLE 903.2.2(1).
4. REFER TO FINISH SCHEDULE FOR SELECTION OF FINISHES.
5. PROVIDE 1/2" SOLID CORE DOOR OR APPROVED 3/4" HONEY COMB DOOR W/ SELF CLOSURE AND TIGHT FITTING.
6. PROVIDE STAIRS AND LANDING: 5/8" TYPE 'X' GYPSUM, 1/4" G.C., OR FLOOR AND CASING OF ENCLOSED ACCESSIBLE AREA.
7. ALL CONCRETE ON 1ST & 2ND FLS PRECAST CONCRETE FINISH ABOVE GRADE.
8. 3/4" HONEY COMB OR 1/2" HONEY COMB FINISH ON 1ST & 2ND FLS. PROVIDE 1/2" SOLID CORE DOOR OR APPROVED 3/4" HONEY COMB DOOR W/ SELF CLOSURE AND TIGHT FITTING.
9. ALL ACCESS LWAYS FINISH TO MATCH LARGEST PIECE OF EQUIPMENT BUT NOT LESS THAN 2" SPACE FROM EQUIPMENT.
10. FINISH AT ALL ACCESSIBLE AREAS: PROVIDE UNRESTRICTED PASSAGEWAY FROM LARGE ROOM TO REMOTE ROOMS: PROVIDE 30" HIGH x 30" WIDE PASSAGEWAY WITH 3/4" HONEY COMB OR APPROVED 3/4" SOLID CORE DOOR AT SERVICE SIDE OF THE EQUIPMENT. PROVIDE 30" HIGH ACCESS POINT TO PANEL LOCATION OF MECHANICAL EQUIPMENT. INSTALL PER GENERAL NOTES.
11. PROVIDE SCHEDULED LOWEST LOWEST ACCESSIBLE FINISH.
12. LOWEST FINISH AS NOTED ON DOUBLE TOP PLATE. SEE DETAIL SCHEDULE.
13. FINISH AT ALL FINISH PROVISIONS.
14. INTERIOR WALLS FINISH TO MATCH EXTERIOR WALLS FOR ELEVATIONS AND DEVELOPMENT.
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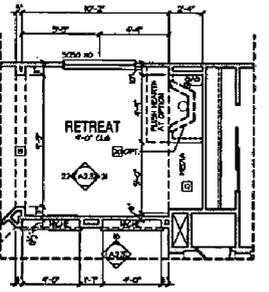
SQUARE FOOTAGES

MAIN FLOOR	1250
UPPER FLOOR	1250
LOFT	300
RETREAT	300
TOTAL	2100
UPPER FLOOR/LOFT/RETREAT	1800
LOFT & RETREAT	600
UPPER FLOOR	1250

Exhibit 6: Upper Floor Plan
(Plan 3)

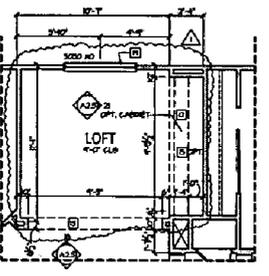

Loft Option
Partial Upper Floor Plan
SCALE: 1/4" = 1'-0"



Retreat Option
Partial Upper Floor Plan
SCALE: 1/4" = 1'-0"



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REGISTERED ARCHITECT
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STATE OF CALIFORNIA

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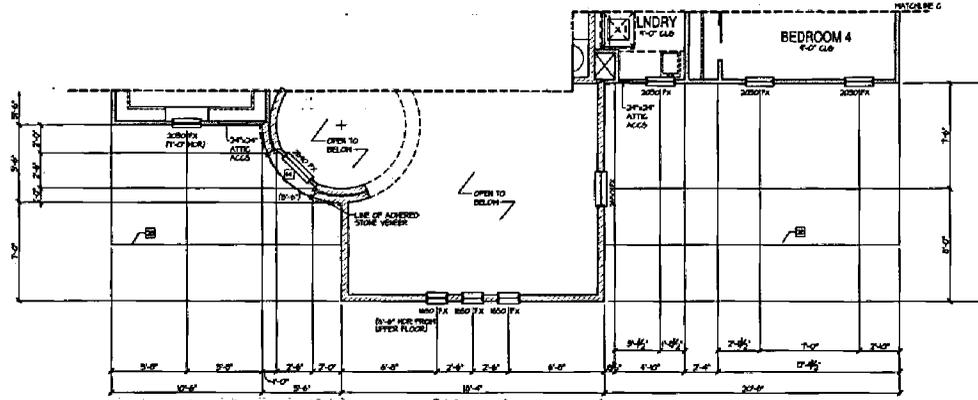
DR. JONATHAN R. SHAW
America's Builder

NATOMAS CREEK 65
SACRAMENTO, CA
Hoodgood Stamp Builders

PLAN 3
A2.2


P04-037
Rec'd 3/2/04

Exhibit 6: Upper Floor Plan
(Plan 3)



**Elevation B
Partial Upper Floor Plan**

SCALE: 1/4"=1'-0" 1/8"=1'-0"

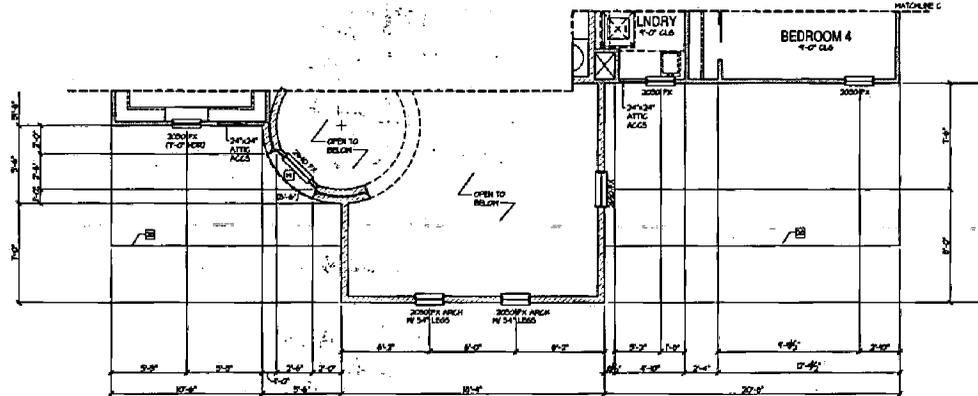

**Elevation C
Partial Upper Floor Plan**

SCALE: 1/4"=1'-0" 1/8"=1'-0"

P04-037
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MAIN FLOOR NOTES

- A. REFER TO GENERAL NOTE SHEETS FOR PLAN GENERAL NOTES.
- B. REFER TO 207 SHEETS FOR COORDINATE OF CENTERLINE AND INSULATION VALUES.
- C. ALL DIMENSIONS SHALL TO BE AS DIMENSIONS AND NOTES OTHERWISE.
- D. MECHANICAL HEAD HEIGHTS:
1ST FLOOR - 8'-0" KING
2ND FLOOR - 8'-0" KING
DOOR HEADS AS NOTED ON PLANS
DASH ADJACENT MECHANICAL HEADS WITH DOOR HEADS.

BLANKET NOTES

1. HOSE TO MANAGE FIRE SEPARATION SURFACE SEPARATION AT VERTICAL SURFACE SHALL BE PROTECTED BY ONE (1) LAYER 5/8" TYPE 'X' GYPSUM BOARD PER CAL. BELL 9024 AND TABLE 7-4.8 ITEM 11-1E.
2. HOSE TO MANAGE DOOR SEPARATION PROVIDE 5/8" SOLID CORE DOOR OR APPROVED 30 MINUTE RATED DOOR IN SELF CLOSURE AND TRIM FITTING.
3. ROOFING BEAMS AND LATHING: 5/8" TYPE 'X' SUPPORTS AT 16" O.C. ON WALLS AND CEILING OF ENCLOSED ACCESSIBLE AREA.
4. 4" AG CONCRETE ON 5/8" X 5/8" MESH PRECAST CONCRETE PANELS OVER INSULATION.
5. 600 WATER HEATER ON 16" HIGH PLATFORM. SIZE PER SCHEDULE. SEE DETAIL AND GENERAL NOTES.
6. ROLLING CONCRETE FILLER BY SHOWN. FIRE LOCATE PER FLOOR FINISH LAYOUT. SEE DETAIL. 10/14.
7. ATTIC ACCESS LAMBE BROWN TO REMOVE LARGEST PIECE OF EQUIPMENT. PROVIDE 20" HIGH X 8" DEEP FRAMEWORK WITH 2" HIDE PLUMBOO FLOORING WITH 20" DEEP PLATFORM AT SERVICE SIDE OF THE EQUIPMENT. HANG 20" X 20" FROM ACCESS POINT TO FLOOR. VERIFY LOCATION BY MECHANICAL DRAWINGS. NOTATE PER GENERAL NOTES.
8. PROVIDE SCHEDULED LOWBOARD LOW CORRELATION AIR VENTS.
9. TYPED SAFETY BLANKS FOR GENERAL NOTES SECTION CHECKS.
10. LOW WALL MOUNT AS NOTED BY DOUBLE TOP PLATE. SEE DETAIL 10/14.
11. 2" PLAT SOFFIT AT 8'-0" KING FRAME DIMENSION AREA.
12. INTERIOR ARCHES FRAME DIMENSIONS TYPICAL. PLAT SOFFIT IN 2" HANG CORNERS. SEE DETAIL ALL FOR ELEVATIONS AND DIMENSIONS.
13. EXTERIOR SOFFIT OR ARCH SEE EXTERIOR ELEVATIONS FOR DIMENSIONS.
14. WALL MOUNTED CABINET ABOVE 24" DEEP UPPER LAMBE BROWN REPRESENTATIVE.
15. DOOR: VENT DUCT SHALL BE OF SMOOTH METAL EXTENDING TO EXTERIOR WITH BACKDRIFT DAMPER PER CAL. AND CAL. HANGING 1" DOWN FROM CEILING TO 10 DEGREE SLOPE. SEE VENT CALCULUS PROVIDED.
16. SHOWERS AND BATHROOM COMBINATIONS: PROVIDE A SMOOTH, HARD, NONABSORBENT SURFACE OVER MECHANICAL PARTS WITH FINISHED BLANKS ENCLOSED.
17. PROVIDE MECHANICAL CONTROL VALVES OF THE PRESSURE DRAINAGE OR THE INDICATORIC PRESSURE VALVE TYPE FOR THE SHOWER AND BATHROOM COMBINATIONS.
18. EMERGENCY EXIT: ONE SIGN IS EA. SLEEPING AREA SHALL COMPLY WITH SCHEDULED FIRE AND BURNING CODES. EXTERIOR WINDOWS SHALL HAVE A NET CLEAR OPENING AREA OF 5.7 SQUARE FEET. THE WINDOW NET CLEAR OPENING SHALL BE 20 INCHES. WINDOW WEIGHTS SHALL BE 20 INCHES. WINDOW WEIGHTS SHALL HAVE A FINISHED SILL HEIGHT OF NOT MORE THAN 44 INCHES ABOVE THE FLOOR.
19. FIRE PARTITIONED METAL 2" DIRECT VENT GAS FIREPLACE. SEE SHEET A2.2 FOR ELEVATIONS. TRIMAL.
20. 2" X 4" BATT INSULATION TO CEILING. FILE ABOVE, SPLASH AND DESK.
21. 2" X 4" BATT INSULATION TO CEILING. FILE ABOVE, SPLASH AND DESK.
22. 2" X 4" BATT INSULATION TO CEILING. FILE ABOVE, SPLASH AND DESK.
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DR-HORION
America's Builders

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SACRAMENTO, CA

4401 Hazel Ave. Ste. 225
Fair Oaks, CA 95628
916-985-2200

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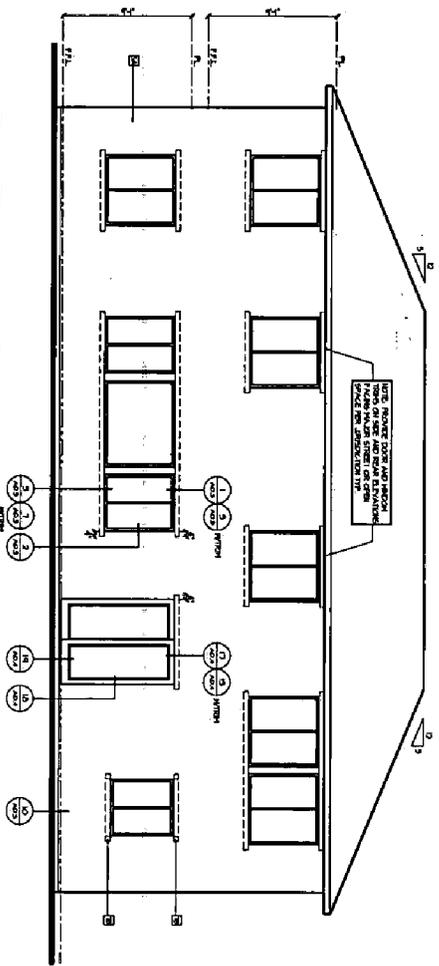
1111 Broadway, Suite 101
Fair Oaks, CA 95628
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Woodgrip Stamp Printer


JOB NO. 04-037 PROJECT 65 DATE 03/02/04 PLAN 3	SHEET NO. 1 TOTAL SHEETS 1 DATE 03/02/04 A2.2A
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Exhibit 6: Elevation A
(Plan 3)

Rear Elevation - A



Spanish-(Villa Tile)
Front Elevation - A

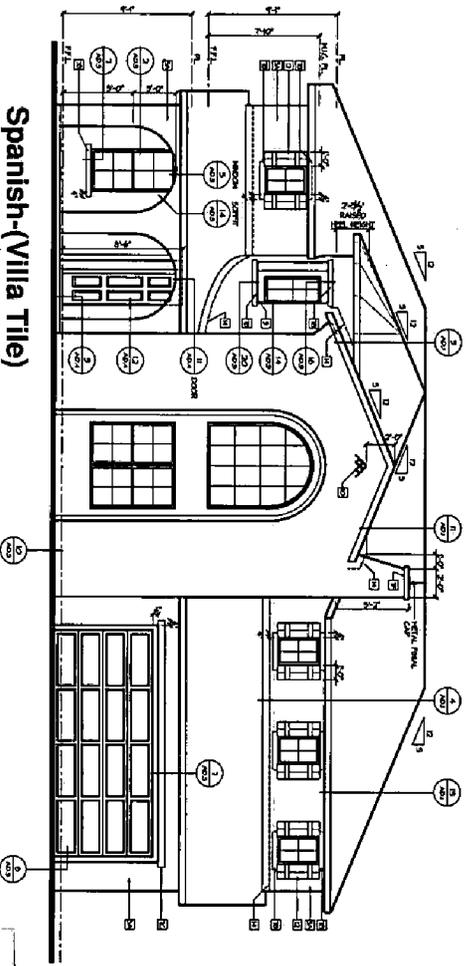


- EXTERIOR ELEVATION NOTES**
1. REFER TO GENERAL NOTES SHEET FOR GENERAL NOTES AND SPECIFICATIONS.
 2. REFER TO GENERAL NOTES SHEET FOR MATERIALS AND FINISHES.
 3. REFER TO GENERAL NOTES SHEET FOR ROOFING AND CEILING.
 4. REFER TO GENERAL NOTES SHEET FOR FLOORING AND WALLS.
 5. REFER TO GENERAL NOTES SHEET FOR PAINTS AND COATINGS.
 6. REFER TO GENERAL NOTES SHEET FOR METALS AND GLASS.
 7. REFER TO GENERAL NOTES SHEET FOR LIGHTING AND ELECTRICAL.
 8. REFER TO GENERAL NOTES SHEET FOR MECHANICAL AND PLUMBING.
 9. REFER TO GENERAL NOTES SHEET FOR LANDSCAPE ARCHITECTURE.
 10. REFER TO GENERAL NOTES SHEET FOR SIGNAGE AND MARKINGS.
 11. REFER TO GENERAL NOTES SHEET FOR ACCESSIBILITY.
 12. REFER TO GENERAL NOTES SHEET FOR SAFETY AND SECURITY.
 13. REFER TO GENERAL NOTES SHEET FOR HISTORIC PRESERVATION.
 14. REFER TO GENERAL NOTES SHEET FOR ENVIRONMENTAL SUSTAINABILITY.
 15. REFER TO GENERAL NOTES SHEET FOR ENERGY EFFICIENCY.
 16. REFER TO GENERAL NOTES SHEET FOR SMART TECHNOLOGY.
 17. REFER TO GENERAL NOTES SHEET FOR WELLNESS AND BIODESIGN.
 18. REFER TO GENERAL NOTES SHEET FOR CULTURAL HERITAGE.
 19. REFER TO GENERAL NOTES SHEET FOR COMMUNITY ENGAGEMENT.
 20. REFER TO GENERAL NOTES SHEET FOR SOCIAL RESPONSIBILITY.


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Rec'd 3/2/04

<p>NATOMAS CREEK 65 SACRAMENTO, CA</p>		<p>D-R-HORTON America's Builder</p>		<p>4401 Hazel Ave. Ste. 225 Fair Oaks, CA 95628 916-965-2200</p>	
<p>1117 Woodland Blvd., Ste. 110 Sacramento, CA 95828 916-486-8888</p>		<p>Office Locations</p> <p>Atlanta • Chicago • Dallas • Denver • Detroit • Houston • Kansas City • Las Vegas • Los Angeles • Miami • Minneapolis • New York • Phoenix • Portland • Raleigh • San Antonio • San Diego • St. Louis • Tampa • Wichita</p>		<p>PERMITS</p> <p>1117 Woodland Blvd., Ste. 110 Sacramento, CA 95828 916-486-8888</p>	
<p>1-5-2004</p>		<p>PERMIT SET</p>		<p>FLY DATE: 03/25/2004 8:04AM</p>	

Exhibit 6: Elevation A
(Plan 3)

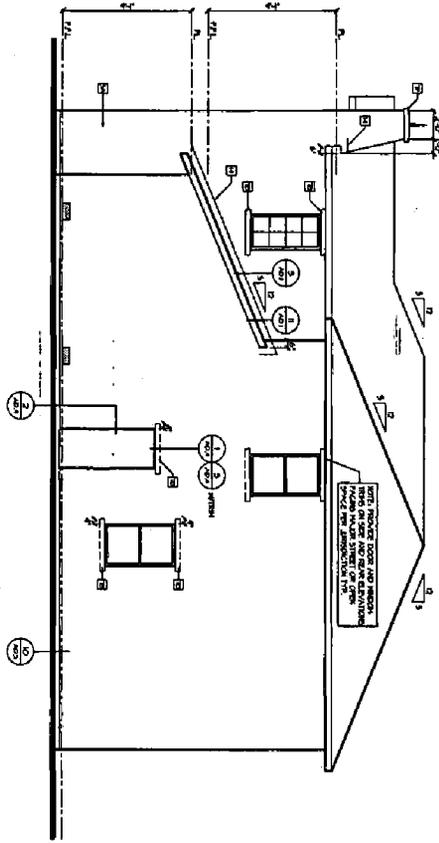

Right Elevation - A

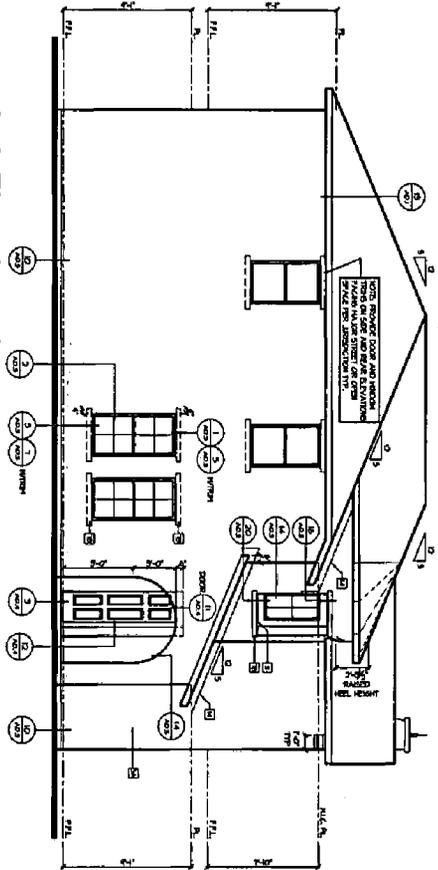

Left Elevation - A

SCALE: 1/8" = 1'-0"

EXTERIOR
ELEVATION NOTES


- A. REFER TO GENERAL NOTES SHEETS 1, 2 & 3 FOR DISCUSSION OF MATERIALS, FINISHES, AND INSTALLATION.
- B. VERIFY LOCAL BUILDING, PLUMBING, MECHANICAL, AND ELECTRICAL CODES AND REQUIREMENTS.
- C. VERIFY ALL MATERIALS AND FINISHES ARE AVAILABLE AND APPROVED BY THE ARCHITECT.
- D. VERIFY ALL MATERIALS AND FINISHES ARE APPROVED BY THE ARCHITECT.
- E. VERIFY ALL MATERIALS AND FINISHES ARE APPROVED BY THE ARCHITECT.
- F. VERIFY ALL MATERIALS AND FINISHES ARE APPROVED BY THE ARCHITECT.
- G. VERIFY ALL MATERIALS AND FINISHES ARE APPROVED BY THE ARCHITECT.
- H. VERIFY ALL MATERIALS AND FINISHES ARE APPROVED BY THE ARCHITECT.
- I. VERIFY ALL MATERIALS AND FINISHES ARE APPROVED BY THE ARCHITECT.
- J. VERIFY ALL MATERIALS AND FINISHES ARE APPROVED BY THE ARCHITECT.

- 1. STUCCO FINISH, TYPE 1, SEE DETAIL.
- 2. STUCCO FINISH, TYPE 2, SEE DETAIL.
- 3. STUCCO FINISH, TYPE 3, SEE DETAIL.
- 4. STUCCO FINISH, TYPE 4, SEE DETAIL.
- 5. STUCCO FINISH, TYPE 5, SEE DETAIL.
- 6. STUCCO FINISH, TYPE 6, SEE DETAIL.
- 7. STUCCO FINISH, TYPE 7, SEE DETAIL.
- 8. STUCCO FINISH, TYPE 8, SEE DETAIL.
- 9. STUCCO FINISH, TYPE 9, SEE DETAIL.
- 10. STUCCO FINISH, TYPE 10, SEE DETAIL.


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<p>117 Woodland Way, Suite 110 Dunsmuir, CA 95923 Phone: 916-931-0200</p>		
<p>Office Locations: #Dunsmuir #Fair Oaks #Fair Oaks</p>		
<p>DATE: 03/02/04 DRAWN BY: [Name] CHECKED BY: [Name] SCALE: 1/8" = 1'-0" PLAN: 3 SHEET: A3.2</p>		

Exhibit 6: Elevation B
(Plan 3)

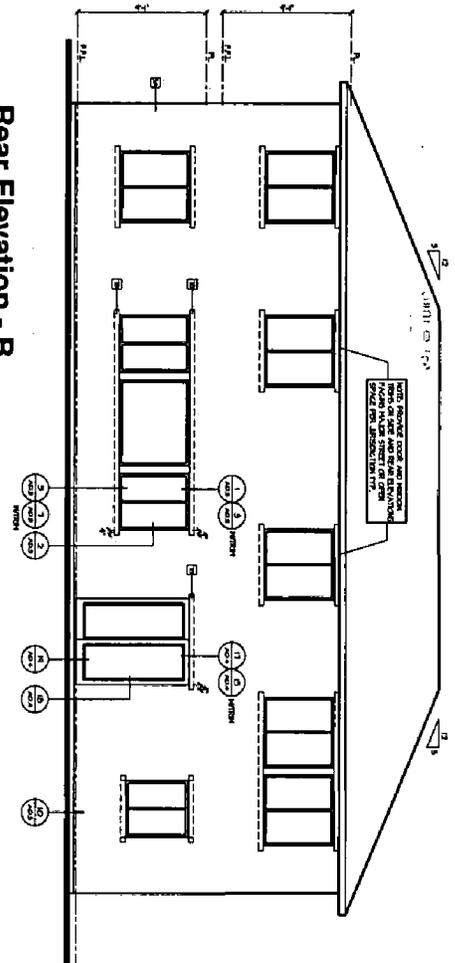

Rear Elevation - B

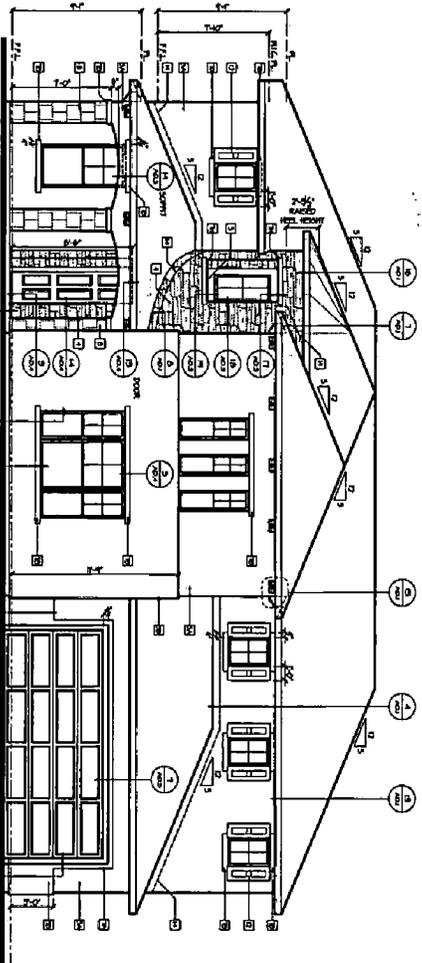

Italian-Villa Tile
Front Elevation - B


EXTERIOR
ELEVATION NOTES

- A. REFER TO GENERAL NOTES SHEETS FOR REVISIONS TO THIS DRAWING.
- B. VERIFY ALL MATERIALS, FINISHES, AND METHODS WITH THE CONTRACTOR AND ARCHITECT BEFORE PROCEEDING WITH CONSTRUCTION.
- C. VERIFY ALL MATERIALS, FINISHES, AND METHODS WITH THE CONTRACTOR AND ARCHITECT BEFORE PROCEEDING WITH CONSTRUCTION.
- D. VERIFY ALL MATERIALS, FINISHES, AND METHODS WITH THE CONTRACTOR AND ARCHITECT BEFORE PROCEEDING WITH CONSTRUCTION.
- E. VERIFY ALL MATERIALS, FINISHES, AND METHODS WITH THE CONTRACTOR AND ARCHITECT BEFORE PROCEEDING WITH CONSTRUCTION.
- F. VERIFY ALL MATERIALS, FINISHES, AND METHODS WITH THE CONTRACTOR AND ARCHITECT BEFORE PROCEEDING WITH CONSTRUCTION.
- G. VERIFY ALL MATERIALS, FINISHES, AND METHODS WITH THE CONTRACTOR AND ARCHITECT BEFORE PROCEEDING WITH CONSTRUCTION.
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- I. VERIFY ALL MATERIALS, FINISHES, AND METHODS WITH THE CONTRACTOR AND ARCHITECT BEFORE PROCEEDING WITH CONSTRUCTION.
- J. VERIFY ALL MATERIALS, FINISHES, AND METHODS WITH THE CONTRACTOR AND ARCHITECT BEFORE PROCEEDING WITH CONSTRUCTION.
- K. VERIFY ALL MATERIALS, FINISHES, AND METHODS WITH THE CONTRACTOR AND ARCHITECT BEFORE PROCEEDING WITH CONSTRUCTION.
- L. VERIFY ALL MATERIALS, FINISHES, AND METHODS WITH THE CONTRACTOR AND ARCHITECT BEFORE PROCEEDING WITH CONSTRUCTION.
- M. VERIFY ALL MATERIALS, FINISHES, AND METHODS WITH THE CONTRACTOR AND ARCHITECT BEFORE PROCEEDING WITH CONSTRUCTION.
- N. VERIFY ALL MATERIALS, FINISHES, AND METHODS WITH THE CONTRACTOR AND ARCHITECT BEFORE PROCEEDING WITH CONSTRUCTION.
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- P. VERIFY ALL MATERIALS, FINISHES, AND METHODS WITH THE CONTRACTOR AND ARCHITECT BEFORE PROCEEDING WITH CONSTRUCTION.
- Q. VERIFY ALL MATERIALS, FINISHES, AND METHODS WITH THE CONTRACTOR AND ARCHITECT BEFORE PROCEEDING WITH CONSTRUCTION.
- R. VERIFY ALL MATERIALS, FINISHES, AND METHODS WITH THE CONTRACTOR AND ARCHITECT BEFORE PROCEEDING WITH CONSTRUCTION.
- S. VERIFY ALL MATERIALS, FINISHES, AND METHODS WITH THE CONTRACTOR AND ARCHITECT BEFORE PROCEEDING WITH CONSTRUCTION.
- T. VERIFY ALL MATERIALS, FINISHES, AND METHODS WITH THE CONTRACTOR AND ARCHITECT BEFORE PROCEEDING WITH CONSTRUCTION.
- U. VERIFY ALL MATERIALS, FINISHES, AND METHODS WITH THE CONTRACTOR AND ARCHITECT BEFORE PROCEEDING WITH CONSTRUCTION.
- V. VERIFY ALL MATERIALS, FINISHES, AND METHODS WITH THE CONTRACTOR AND ARCHITECT BEFORE PROCEEDING WITH CONSTRUCTION.
- W. VERIFY ALL MATERIALS, FINISHES, AND METHODS WITH THE CONTRACTOR AND ARCHITECT BEFORE PROCEEDING WITH CONSTRUCTION.
- X. VERIFY ALL MATERIALS, FINISHES, AND METHODS WITH THE CONTRACTOR AND ARCHITECT BEFORE PROCEEDING WITH CONSTRUCTION.
- Y. VERIFY ALL MATERIALS, FINISHES, AND METHODS WITH THE CONTRACTOR AND ARCHITECT BEFORE PROCEEDING WITH CONSTRUCTION.
- Z. VERIFY ALL MATERIALS, FINISHES, AND METHODS WITH THE CONTRACTOR AND ARCHITECT BEFORE PROCEEDING WITH CONSTRUCTION.


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NATOMAS CREEK 65 SACRAMENTO, CA	D-R HORTON <i>America's Builder</i>	4401 Hazel Ave. Ste. 225 Fair Oaks, CA 95628 918-985-2200	OFFICE LOCATIONS • Los Angeles • Tampa • Sacramento • Chicago • Phoenix • Dallas • San Diego • Houston • Portland • Denver • Salt Lake City
1177 Woodland Way, Suite 110 Dunsmuir, CA 95929 Phone: 916-511-0297	1177 Woodland Way, Suite 110 Dunsmuir, CA 95929 Phone: 916-511-0297		
25% of the cost of the work shown on this plan is to be paid by the owner at the time of the start of construction. The balance of the cost is to be paid in 12 equal installments over the course of the construction.	THE CONTRACTOR SHALL BE RESPONSIBLE FOR OBTAINING ALL NECESSARY PERMITS AND INSURANCE. THE CONTRACTOR SHALL BE RESPONSIBLE FOR THE PROTECTION OF ALL EXISTING UTILITIES AND STRUCTURES. THE CONTRACTOR SHALL BE RESPONSIBLE FOR THE PROTECTION OF ALL EXISTING TREES AND LANDSCAPING. THE CONTRACTOR SHALL BE RESPONSIBLE FOR THE PROTECTION OF ALL EXISTING MATERIALS AND FINISHES. THE CONTRACTOR SHALL BE RESPONSIBLE FOR THE PROTECTION OF ALL EXISTING WORK. THE CONTRACTOR SHALL BE RESPONSIBLE FOR THE PROTECTION OF ALL EXISTING WORK.		

Exhibit 6: Elevation C
(Plan 3)

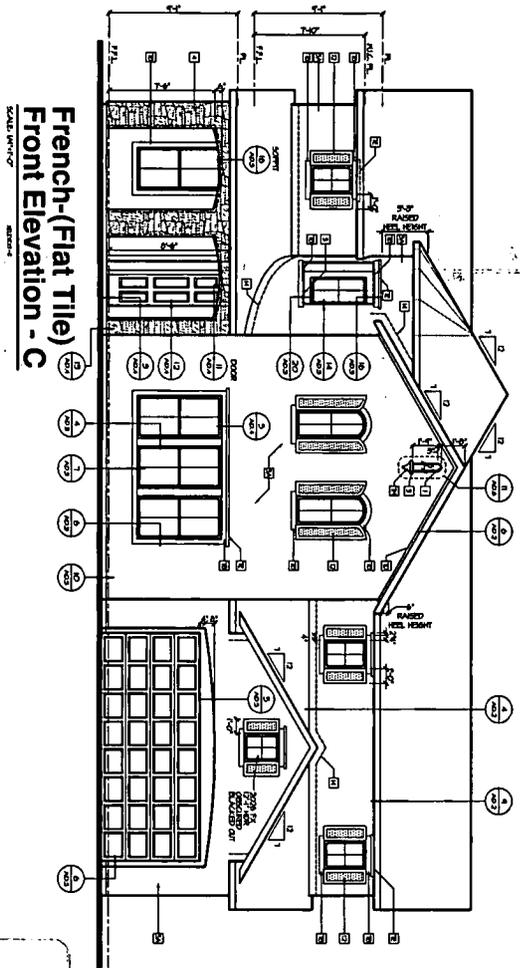

Rear Elevation - C



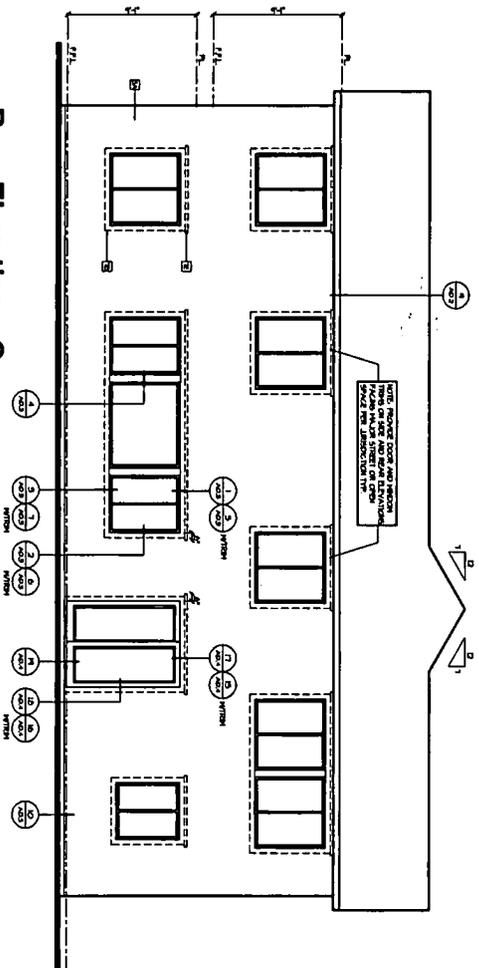


- EXTERIOR ELEVATION NOTES**
- A. REFER TO GENERAL NOTES SHEETS FOR INFORMATION ON MATERIALS, FINISHES, AND CONSTRUCTION METHODS.
 - B. WINDOW SIZES AND SPACING SHALL BE AS SHOWN ON THIS ELEVATION. WINDOW SIZES SHALL BE AS SHOWN ON THIS ELEVATION UNLESS OTHERWISE NOTED.
 - C. WINDOW SIZES SHALL BE AS SHOWN ON THIS ELEVATION UNLESS OTHERWISE NOTED.
 - D. WINDOW SIZES SHALL BE AS SHOWN ON THIS ELEVATION UNLESS OTHERWISE NOTED.
 - E. WINDOW SIZES SHALL BE AS SHOWN ON THIS ELEVATION UNLESS OTHERWISE NOTED.
 - F. WINDOW SIZES SHALL BE AS SHOWN ON THIS ELEVATION UNLESS OTHERWISE NOTED.
 - G. WINDOW SIZES SHALL BE AS SHOWN ON THIS ELEVATION UNLESS OTHERWISE NOTED.
 - H. WINDOW SIZES SHALL BE AS SHOWN ON THIS ELEVATION UNLESS OTHERWISE NOTED.
 - I. WINDOW SIZES SHALL BE AS SHOWN ON THIS ELEVATION UNLESS OTHERWISE NOTED.
 - J. WINDOW SIZES SHALL BE AS SHOWN ON THIS ELEVATION UNLESS OTHERWISE NOTED.
 - K. WINDOW SIZES SHALL BE AS SHOWN ON THIS ELEVATION UNLESS OTHERWISE NOTED.
 - L. WINDOW SIZES SHALL BE AS SHOWN ON THIS ELEVATION UNLESS OTHERWISE NOTED.
 - M. WINDOW SIZES SHALL BE AS SHOWN ON THIS ELEVATION UNLESS OTHERWISE NOTED.
 - N. WINDOW SIZES SHALL BE AS SHOWN ON THIS ELEVATION UNLESS OTHERWISE NOTED.
 - O. WINDOW SIZES SHALL BE AS SHOWN ON THIS ELEVATION UNLESS OTHERWISE NOTED.
 - P. WINDOW SIZES SHALL BE AS SHOWN ON THIS ELEVATION UNLESS OTHERWISE NOTED.
 - Q. WINDOW SIZES SHALL BE AS SHOWN ON THIS ELEVATION UNLESS OTHERWISE NOTED.
 - R. WINDOW SIZES SHALL BE AS SHOWN ON THIS ELEVATION UNLESS OTHERWISE NOTED.
 - S. WINDOW SIZES SHALL BE AS SHOWN ON THIS ELEVATION UNLESS OTHERWISE NOTED.
 - T. WINDOW SIZES SHALL BE AS SHOWN ON THIS ELEVATION UNLESS OTHERWISE NOTED.
 - U. WINDOW SIZES SHALL BE AS SHOWN ON THIS ELEVATION UNLESS OTHERWISE NOTED.
 - V. WINDOW SIZES SHALL BE AS SHOWN ON THIS ELEVATION UNLESS OTHERWISE NOTED.
 - W. WINDOW SIZES SHALL BE AS SHOWN ON THIS ELEVATION UNLESS OTHERWISE NOTED.
 - X. WINDOW SIZES SHALL BE AS SHOWN ON THIS ELEVATION UNLESS OTHERWISE NOTED.
 - Y. WINDOW SIZES SHALL BE AS SHOWN ON THIS ELEVATION UNLESS OTHERWISE NOTED.
 - Z. WINDOW SIZES SHALL BE AS SHOWN ON THIS ELEVATION UNLESS OTHERWISE NOTED.

P04-037
Rec'd 3/2/04

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<p>1177 Woodland Way, Suite 110 Sacramento, CA 95834 Phone: 916-941-0882</p>		<p>Office Locations</p> <p>•Daly City •Folsom •Fremont •Hayward •Livermore •Oakland •San Francisco •San Jose •Stockton •Tracy</p>		<p>PERMIT SET</p> <p>DATE: 02/25/2004 10:54 AM</p>	

Exhibit 7: Main Floor Plan
(Plan 4)

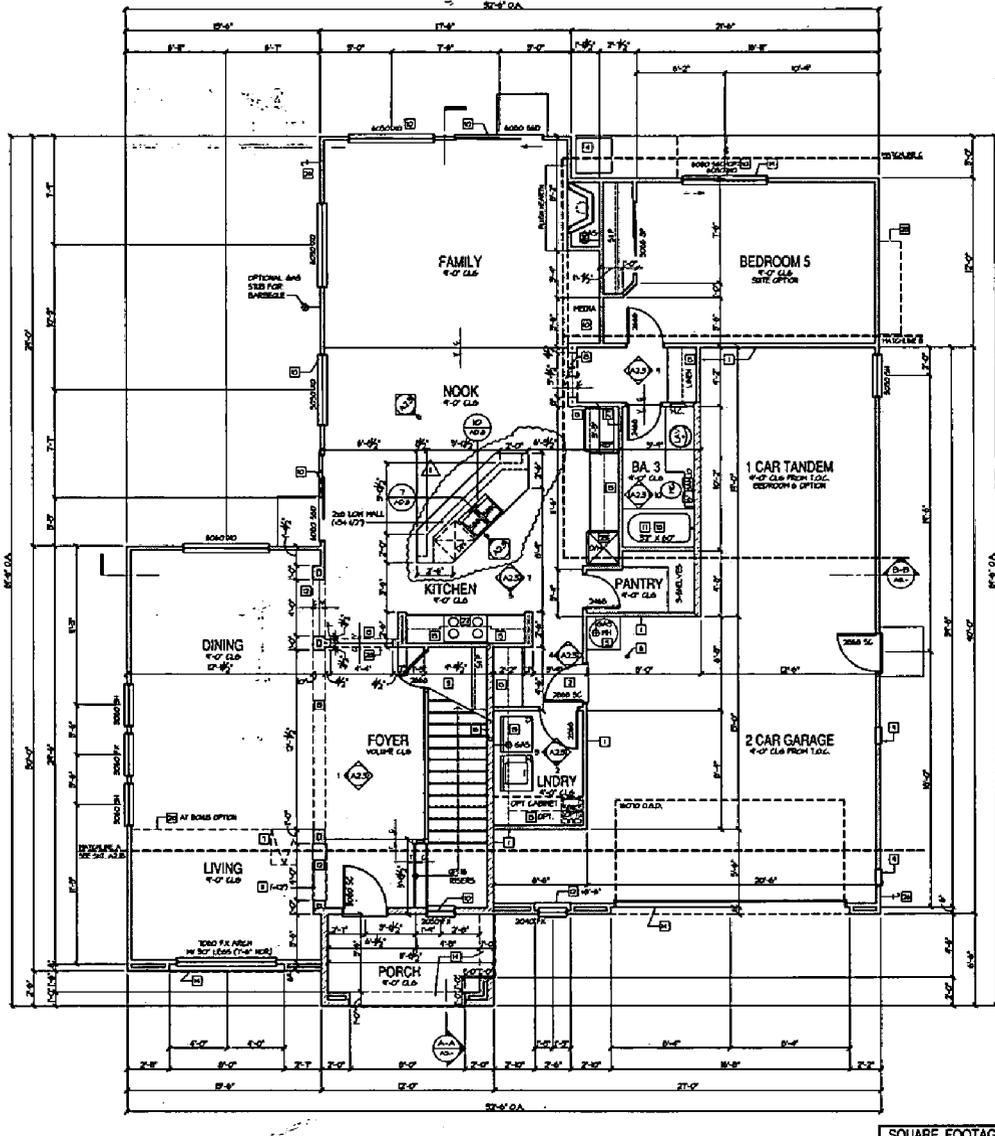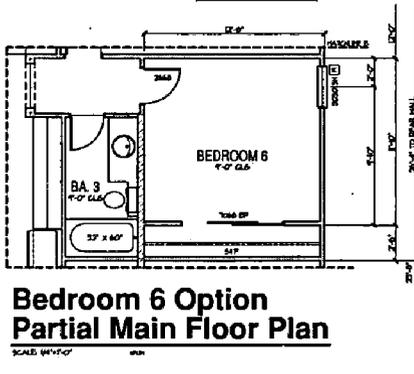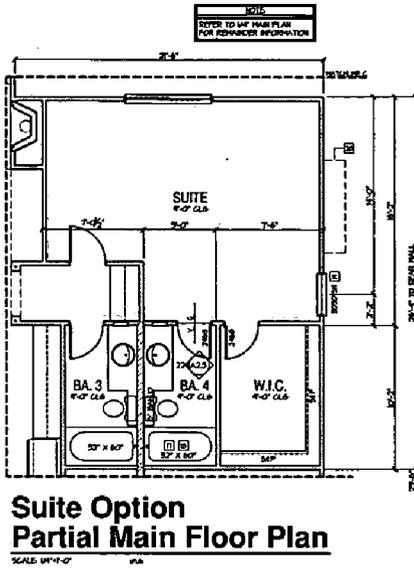

SQUARE FOOTAGES

MAIN FLOOR	1731
UPPER FLOOR	1030
BASEMENT	1846
TOTAL	4607
NET 1 SUITE OPTION	333
GARAGE AT BED & OPT. SUITE OPTION	218

- ### MAIN FLOOR NOTES
- REFER TO GENERAL NOTE SHEETS FOR PLAN GENERAL NOTES
 - REFER TO 307 SHEETS FOR CERTIFICATE OF COMPLIANCE AND REDUCTION VALUES
 - ALL DIAGONAL WALLS TO BE 45 DEGREES UNLESS NOTED OTHERWISE
 - MINIMUM 3/4" X 3/4" STUDS
 - 1ST FLOOR - 16" O.C.
 - 2ND FLOOR - 8" O.C.
 - DOOR HEADS AND WINDOW HEADS SHALL BE 16" O.C.
 - 16" O.C. ADJACENT WINDOW HEADS NEAR 16" O.C. DOOR HEADS
- ### FINISH NOTES
- WALL TO GARAGE FIBER SEPARATION: PARALLEL TO SEPARATION AT VERTICAL SURFACE SHALL BE PROTECTED WITH ONE (1) LAYER, 5/8" TYPE 'X' GYPSUM BOARD PER CIRC. TABLE 14. ITEM SHALL BE TABLE 14.8 ITEM 1-1C.
 - WALL TO GARAGE DOOR SEPARATION: PROVIDE 1/2" SOLID CORE DOOR OR APPROXIMATE 20 MINUTE RATED DOOR BY SELF CLOSURE AND TIGHT FITTING.
 - WALLS: SHOWN STRIPES AND LAMINATE. 1/4" TYPE 'X' SURFACES AT 16" O.C. OR WALLS AND CEILING OF ENCLOSED ACCESSIBLE AREA.
 - FINISH CONCOURSE OR 3" x 6" FIBER REINFORCED CONCRETE FILL. 1/2" MINIMUM ABOVE GRADE.
 - WALL WATER HEATER OR BY HIGH PLUMBING SIZE FOR WATER. SEE DETAIL KND3 AND KND5.
 - ROLLERS: CONCRETE FILLED 3/4" SPANDED FIBER. LOCATE PER SLAB FORMER LAYOUT. SEE DETAIL KND4.
 - ATTIC ACCESS: LAMINATE BRUSH TO REMOVE LARGEST PIECE OF EQUIPMENT BUT NOT LESS THAN 30" X 42" SEE DETAIL KND4.
 - FAN IN ATTIC ABOVE: PROVIDE UNRESTRICTED PASSAGEWAY TO REMOVE LARGEST PIECE OF EQUIPMENT. PROVIDE 30" HIGH x 30" WIDE PARALLEL 1" x 2" INCH REINFORCED FLOORING WITH 20" WIDE PLATFORM AT SERVICE SIDE OF THE EQUIPMENT. MAX. 20" DEPT. FROM ALLEYS PORT TO FAN. VERIFY LOCATION BY MECHANICAL DRAWINGS. INSTALL PER GENERAL NOTES.
 - PROVIDE SCHEDULED LEANED LON CONSTRUCTION AND PER GENERAL NOTES SECTION CROSS.
 - WALLS: VERIFY AS NOTED. IN DOUBLE TOP SEE DETAIL KND3.
 - WALL FINISHES: 1/4" TYPE 'X' GYPSUM BOARD OVER STUDS AND OVERLAP. SEE DETAIL KND4.
 - WALL MOUNTED CABINET ABOVE: 3/4" DEEP UPPER CABINETS ABOVE REFRIGERATOR.
 - INTERIOR WOODS: INCLUDE DIMENSIONS TYPICAL. FINISH: SPLIT OAK VENEER OVER 3/4" GYPSUM BOARD. SEE DETAIL KND4.
 - WALL MOUNTED CABINET ABOVE: 3/4" DEEP UPPER CABINETS ABOVE REFRIGERATOR. VERIFY: VERIFY DETAIL SHALL BE OF SMOOTH METAL EXTERIOR TO EXTERIOR WITH INSULATION. BRACKET PER CIRC AND DETAIL FINISHES IF LIGHTS PROVIDE TWO (2) GEARLESS LIGHTS. VERIFY: VERIFY DETAIL SHALL BE OF SMOOTH METAL EXTERIOR TO EXTERIOR WITH INSULATION. BRACKET PER CIRC AND DETAIL FINISHES IF LIGHTS PROVIDE TWO (2) GEARLESS LIGHTS. VERIFY: VERIFY DETAIL SHALL BE OF SMOOTH METAL EXTERIOR TO EXTERIOR WITH INSULATION. BRACKET PER CIRC AND DETAIL FINISHES IF LIGHTS PROVIDE TWO (2) GEARLESS LIGHTS.
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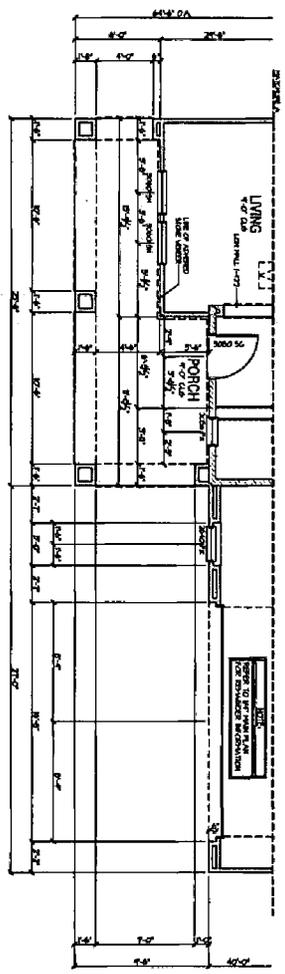
Bloodgood Stamp Buster

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Oakland, CA 94628
Fair 916-866-1200


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Exhibit 7: Main Floor Plan
(Plan 4)



Elevation B
Partial Main Floor Plan



Elevation C
Partial Main Floor Plan


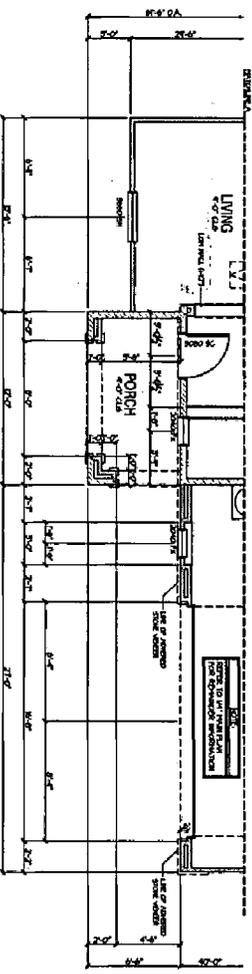
MAIN FLOOR NOTES

1. REFER TO GENERAL NOTE SHEET FOR PLAN
2. REFER TO GENERAL NOTE SHEET FOR FINISH
3. ALL DIMENSIONS UNLESS OTHERWISE NOTED ARE IN FEET AND INCHES.
4. ALL DIMENSIONS SHALL BE TO FACE UNLESS OTHERWISE NOTED.
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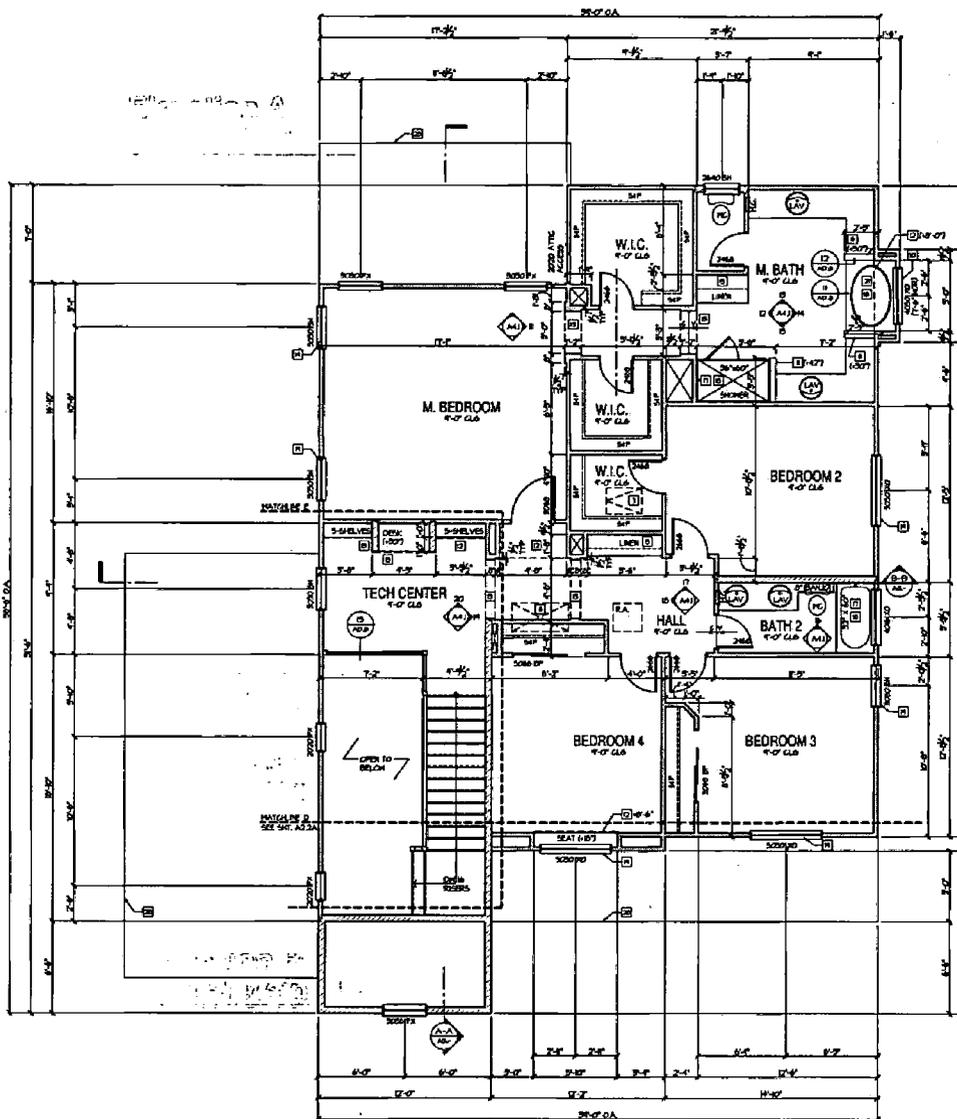
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<p>1177 Woodland Hwy. Suite 118 D. Davis, CA 95618 Phone: 916-911-0800</p>		<p>Office Locations</p>		<p>1177 Woodland Hwy. Suite 118 D. Davis, CA 95618 Phone: 916-911-0800</p>	

Exhibit 7: Upper Floor Plan
(Plan 4)



**Bonus Option-Elevation A/B
Partial Upper Floor Plan**

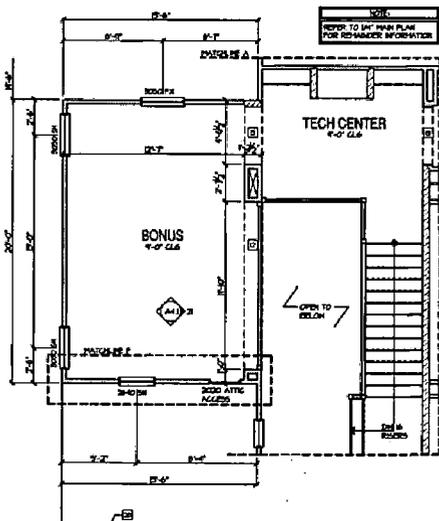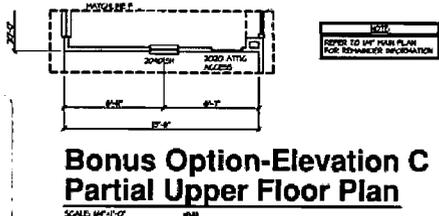

MAIN FLOOR NOTES

- A. REFER TO GENERAL NOTE SHEETS FOR PLAN ROOMING NOTES.
- B. REFER TO THE SHEETS FOR CERTIFICATE OF COMPLIANCE AND RESOLUTION VALUES.
- C. ALL DIMENSION WALLS TO BE 40 DEGREES UNLESS NOTED OTHERWISE.
- D. HATCH ROOM HEIGHTS:
-1ST FLOOR - 8'-0" RIGID
-2ND FLOOR - 8'-0" RIGID
DOOR HEIGHTS AS NOTED ON PLANS
(ALLOW ADJACENT HATCH HEIGHTS ABOUT THE DOOR HEADERS.)

- PLAN SPEC NOTES**
- 1. WALLS TO PROVIDE FIRE SEPARATION (WALLS TO PROVIDE SEPARATION AT VERTICAL SURFACES SHALL BE PROTECTED WITH ONE 1/2" LAYER 5/8" TYPE 'X' GYPSON BOARD FOR EACH S.E.C.T. 3034 AND TABLE 108.10B FIVE.)
 - 2. WALLS TO PROVIDE SOUND SEPARATION (WALLS TO PROVIDE SEPARATION AT HORIZONTAL SURFACES SHALL BE PROTECTED WITH ONE 1/2" LAYER 5/8" TYPE 'X' GYPSON BOARD FOR EACH TABLE 108.10B FIVE.)
 - 3. WOODS TO PROVIDE DOOR SEPARATION (PROVIDE 1 3/8" SOLID CORE DOOR OR APPROVED 30 MIL REED DOOR W/ SELF CLOSURE AND TIGHT FITTING.)
 - 4. BREATH STAIRS AND LIFELINES (SEE TYPE 'X' SPECIFICATIONS ON WALLS AND CEILING OF ENCLOSED ACCESSIBLE AREAS.)
 - 5. AIR CONDENSER ON 30" x 30" PRECAST CONCRETE PAD, 3" MINIMUM ABOVE GRADE.
 - 6. SHOWER WATER HEATED ON 2" MAIN PLUMBING FOR EACH BATH, UNLESS NOTED OTHERWISE.
 - 7. INTERIOR CONCRETE FLOORS TO BE FINISHED WITH LOCALS FOR SLAB FINISHER LAYOUT.
 - 8. ATTIC ACCESS LUNGE DECKS TO PROVIDE LARGEST ACCESSIBLE CLEARANCE BUT NOT LESS THAN 30" WIDE, SEE DETAIL, TABLE 108.10B FIVE.
 - 9. FIRE IN ATTIC ABOVE, PROVIDE UNRESTRICTED PASSAGEWAY WHICH IS LARGEST DIMENSION TO REMOVE THE LARGEST PORTION OF EQUIPMENT PROVIDE 30" HIGH x 30" DEEP PASSAGEWAY WITH 1/2" MIN. CLEARANCE FROM WALLS AND 30" WIDE PLUMBING AT SERVICE SIDE OF THE EQUIPMENT, MAX. 30" OF FLOOR ACCESS POINT TO FIRE EXTINGUISHER, SEE GENERAL NOTES.
 - 10. PROVIDE SCHEDULED LOUVERED LIGHT COORDINATION AIR VENTS.
 - 11. PROVIDE SAFETY GLASS FOR GENERAL NOTES SECTION DECKS.
 - 12. LOW WALL, HEIGHT AS NOTED BY CODES TO TOP PLATE, SEE DETAIL, TABLE 108.10B FIVE (2) PLUMBING, 1/2" AFF. (10').
 - 13. FLOOR SUPPLY AT 8'-0" BSLA PROVIDE EXPOSURE AREAS.
 - 14. INTERIOR FINISHES, PROVIDE EXPOSURE TYPICAL, 1/2" AFF. TO TOP OF FINISH CONCRETE, SEE SHEET A4 FOR ELEVATIONS AND DIMENSIONS, SEE EXTERIOR ELEVATIONS FOR DIMENSIONS.
 - 15. WALL MOUNTED CABINET ABOVE, 30" DEEP UPON CABINETS ABOVE REFRIGERATOR.
 - 16. DOOR, VENT DUCT SHALL BE OF 30" METAL EXTENDING TO EXTERIOR WITH MISCELLANEOUS DIMENSIONS PER CODE AND G.P.C. HANGERS THROUGH VENTS TO 4" MINIMUM ABOVE FLOOR UNLESS VENT CALLS ARE PROVIDED.
 - 17. SHOWERS AND TUBS/TOPHER COMBINATION PROVIDE A SPECIAL INSULATED REFRIGERATION SURFACE OVER INSULATION/REGULATED SYSTEM BOUND TO A HEIGHT OF 107 INCHES ABOVE DEAN INLET, SCHEDULED READ 45-1, (TYPED) (SLAB IS BELIEVED)
 - 18. PROVIDE REMOTE CONTROL VALVES OF THE PRESSURE BALANCE OR THE THERMOSTATIC AREA VALVE TYPE FOR 201 SHOWERS AND TUBS/TOPHER COMBINATION.
 - 19. EXTERIOR EXPOSED, ONE EACH AREA, EXPOSED AREA SHALL COVER 1/2" OVER EXPOSURE FIRE AND BALDING COVER, EXPOSED AREA SHALL HAVE A NET CLEAR OPENABLE AREA OF 57 SQUARE FEET, THE MINIMUM NET CLEAR OPENABLE HEIGHT DIMENSION SHALL BE 34 INCHES AND THE MINIMUM NET OPENABLE WIDTH DIMENSION SHALL BE 30 INCHES, EXPOSED HATCHES SHALL HAVE A FINISHED FLOOR HEIGHT OF 54 INCHES TO 56 INCHES ABOVE THE FLOOR.
 - 20. PRE-FABRICATED METAL 30" CORNER VENT AND INSULATION PER INSET 23.2 (FOR ELEVATIONS, METAL AND INSULATION SHALL BE IN ACCORDANCE WITH THE MANUFACTURER'S REQUIREMENTS).
 - 21. 40" x 60" PRECAST AND TYPICAL, TILE APPROX. 10' HIGH AND 6" DEEP.
 - 22. 30" WIDE CONCEAL W/ 30" RIGID LINEN, EXPOSED FIN ABOVE, VENT FOR GENERAL NOTES SECTION DECKS.
 - 23. 30" ELECTRIC OVER W/ INTERNAL MICROSHAVE OVER.
 - 24. LINEN IN WARDROBE, FIVE (5) 30" DEEP SHELVES.
 - 25. HANGER DRAIN PAN AT SECOND FLOOR ONLY, DRAIN TO EXTERIOR.
 - 26. EXTERIOR HOSE DRINK, PROVIDE WITH NON-REMOVABLE PROTECTION PREVENTION DEVICES.
 - 27. COOL WATER 30" DIA.
 - 28. SHOWERS AND TUBS/TOPHER COMBINATION SHALL BE OF 30" METAL EXTENDING TO EXTERIOR WITH MISCELLANEOUS DIMENSIONS PER CODE AND G.P.C. HANGERS THROUGH VENTS TO 4" MINIMUM ABOVE FLOOR UNLESS VENT CALLS ARE PROVIDED.

SQUARE FOOTAGES	
1ST FLOOR	1776
2ND FLOOR	2852
MECH. ROOM	244
STAIRS	134
TOTAL	4806
MECH. ROOM	244
STAIRS	134
BONUS OPTION	275
CANALY (OPTION)	11

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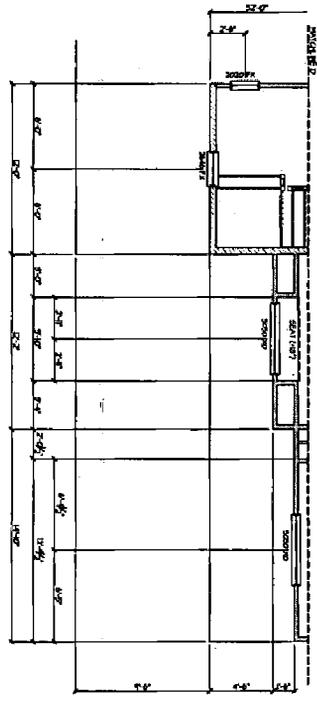
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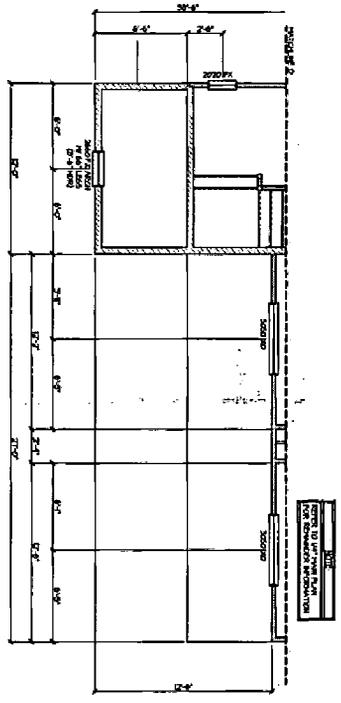
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BY: D. HORTON
PROJECT NO. 04-037
SHEET NO. A2.2

Exhibit 7: Upper Floor Plan
(Plan 4)

Elevation B
Partial Upper Floor Plan



Elevation C
Partial Upper Floor Plan



- MAIN FLOOR NOTES**
1. REFER TO GENERAL NOTES SHEETS FOR PLAN.
 2. REFER TO ALL APPLICABLE CODES AND ORDINANCES.
 3. ALL DIMENSIONS UNLESS OTHERWISE NOTED.
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DATE: 03/20/04	BY: [Signature]
PROJECT: NATOMAS CREEK 65	PLAN: A2.2A
SCALE: AS SHOWN	DATE: 03/20/04

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SACRAMENTO, CA

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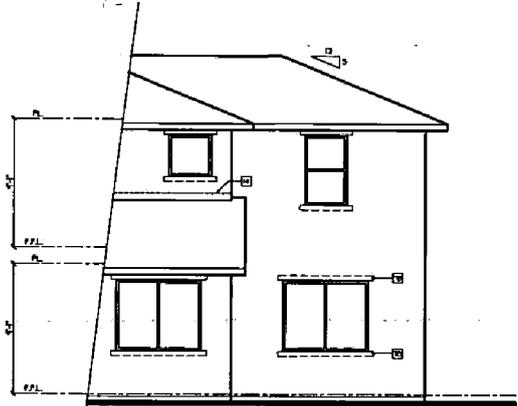
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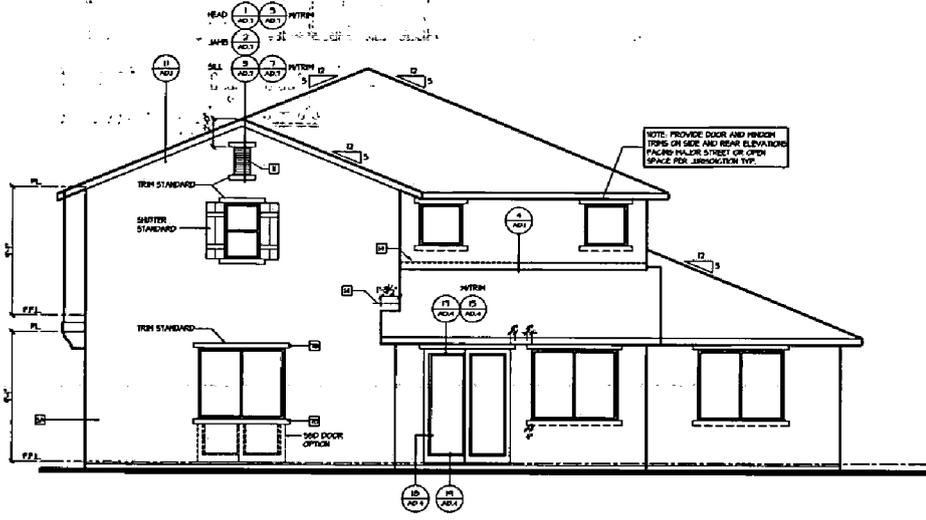


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Exhibit 7: Elevation A
(Plan 4)



**Bonus Option
Partial Rear Elevation - A**
SCALE: 1/4"=1'-0" 10/20/04



Rear Elevation - A
SCALE: 1/4"=1'-0" 10/20/04



**Bonus Option
Partial Front Elevation - A**
SCALE: 1/4"=1'-0" 10/20/04



**Spanish-(Villa Tile)
Front Elevation - A**
SCALE: 1/4"=1'-0" 10/20/04

EXTERIOR ELEVATION NOTES

- A. REFER TO GENERAL NOTE SHEETS FOR TYPICAL REQUIREMENTS AND SPECIFIC DESCRIPTIONS OF MATERIALS.**
- B. WINDOW HEAD HEIGHTS:
- 1ST FLOOR - 8'-0" UNO, ON EXT. ELEVATION
- 2ND FLOOR - 8'-0" UNO
DOOR HEIGHTS AS NOTED ON PLANS.
(FALSE WINDOW HEADERS HEIGHT WITH DOOR HEADERS.)**
- C. EXTERIOR WALLS:
- STEEL SYSTEM OVER 7' FORM INSULATION PER GENERAL NOTES. CORROSION RESISTANT NESH REQUIRED AT JOINTS.
- STEEL SYSTEM OVER 7' FORM INSULATION PER GENERAL NOTES.**
- D. EXTERIOR ROOFING:
- STEEL PER GENERAL NOTES.**
- E. ROOFING:
- GLASS IN THE RETARDANT CONCRETE TILES. ELEVATION A1: LOW-PROFILE CONCRETE TILE PER GENERAL NOTES. SEE ROOFING DETAILS FOR FASCIA. ELEVATION B1: LOW-PROFILE CONCRETE TILE PER GENERAL NOTES. SEE ROOFING DETAILS FOR FASCIA. ELEVATION C1: FLAT CONCRETE TILE PER GENERAL NOTES. SEE ROOFING DETAILS FOR FASCIA.**
- ELEVATION KEY NOTES**
- 1 STEEL JOIST - 2" ROUGH SIZE AS NOTED. SEE DETAILS. DEGENERATIVE RESISTANT FROM INSIDE SHEATH.
 - 2 STEEL JOIST / FLOOR WALL. STEEL OVER ELASTOMERIC FLASHING. SEE EXTERIOR ELEVATIONS FOR DETAIL.
 - 3 SLOPING SURFACE. STEEL OVER ELASTOMERIC FLASHING. SEE DETAIL. UADA.
 - 4 ADHERED STONE VENER AS SELECTED BY BUILDER. HEIGHT AS NOTED. SEE DETAIL.
 - 5 A. STEEL JOIST TYP. B. STEEL JOIST TYP.
 - 6 ADHERED STONE VENER TYP. SEE DETAIL.
 - 7 STEEL OVER FORM TYP.
 - A. 2"x4" FORM IN STEEL OVER
 - B. 2"x4" FORM IN STEEL OVER
 - C. 2"x4" FORM IN STEEL OVER
 - D. 2"x4" FORM IN STEEL OVER
 - E. 2"x4" FORM IN STEEL OVER
 - F. 2"x4" FORM IN STEEL OVER
 - G. 2"x4" FORM IN STEEL OVER
 - H. 2"x4" FORM IN STEEL OVER
 - I. 4"x4" FORM IN STEEL OVER
 - J. 4"x4" FORM IN STEEL OVER
 - K. 2"x4" FORM IN STEEL OVER
 - L. 2"x4" FORM IN STEEL OVER
 - M. SWIPPED FORM IN STEEL OVER
 - 8 SCORED STEEL JOIST.
 - 9 DECORATIVE PROMENT IRON. SEE DETAILS.
 - 10 1/2" HALF ROUND 2" DEEP FLYING HOISTED DECORATIVE CLAY PIPES. SEE ELEVATIONS AND DETAIL BOND.
 - 11 CORROSION RESISTANT SCREEN LOWERED WITH 1/4" X 1/4" BOLD. SEE EXTERIOR ELEVATION FOR DETAILS.
 - 12 FALSE WOOD SHUTTERS. TYPE AS SHOWN. SEE DETAILS S-WOOD.
 - 13 LOWERED FINISH. SEE DETAIL BOND.
 - 14 CORROSION RESISTANT ROOF TO WALL FLASHING. SEE ROOF DETAILS.



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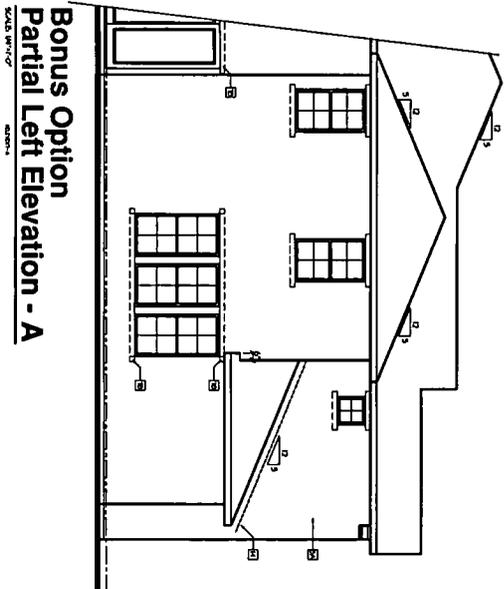
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SACRAMENTO, CA
1177 Broadway, Ste. 1110
Sacramento, CA 95811-2000
Phone: (916) 941-1000
Fax: (916) 941-1001

DATE OF SHEET	NO. OF SHEETS	TOTAL SHEETS
DESIGNED BY	DRAWN BY	CHECKED BY
PLAN 4		
HEET NO.	OF SHEETS	SCALE
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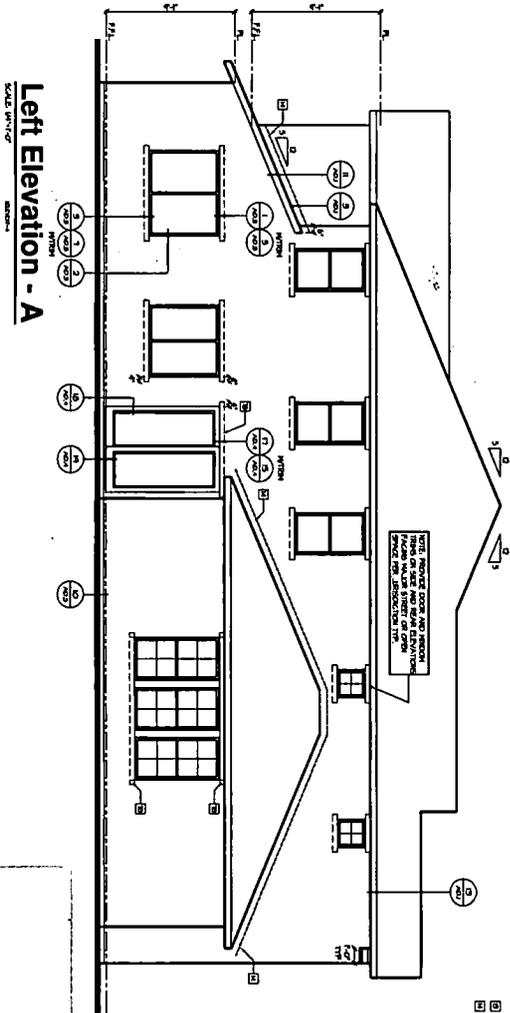
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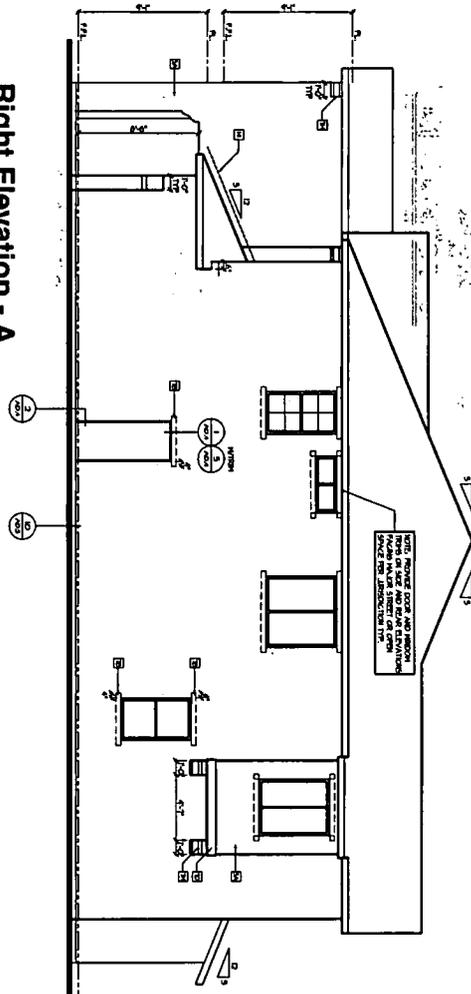
Exhibit 7: Elevation A
(Plan 4)



Bonus Option
Partial Left Elevation - A



Left Elevation - A




Right Elevation - A

- EXTERIOR ELEVATION NOTES**
- A. REFER TO GENERAL NOTES FOR ALL NOTES AND SPECIFICATIONS.
 - B. FINISHES TO BE OF THE SAME TYPE AND MATERIALS AS SHOWN ON THE ELEVATION.
 - C. FINISHES TO BE OF THE SAME TYPE AND MATERIALS AS SHOWN ON THE ELEVATION.
 - D. FINISHES TO BE OF THE SAME TYPE AND MATERIALS AS SHOWN ON THE ELEVATION.
 - E. FINISHES TO BE OF THE SAME TYPE AND MATERIALS AS SHOWN ON THE ELEVATION.
 - F. FINISHES TO BE OF THE SAME TYPE AND MATERIALS AS SHOWN ON THE ELEVATION.
 - G. FINISHES TO BE OF THE SAME TYPE AND MATERIALS AS SHOWN ON THE ELEVATION.
 - H. FINISHES TO BE OF THE SAME TYPE AND MATERIALS AS SHOWN ON THE ELEVATION.
 - I. FINISHES TO BE OF THE SAME TYPE AND MATERIALS AS SHOWN ON THE ELEVATION.
 - J. FINISHES TO BE OF THE SAME TYPE AND MATERIALS AS SHOWN ON THE ELEVATION.
 - K. FINISHES TO BE OF THE SAME TYPE AND MATERIALS AS SHOWN ON THE ELEVATION.
 - L. FINISHES TO BE OF THE SAME TYPE AND MATERIALS AS SHOWN ON THE ELEVATION.
 - M. FINISHES TO BE OF THE SAME TYPE AND MATERIALS AS SHOWN ON THE ELEVATION.
 - N. FINISHES TO BE OF THE SAME TYPE AND MATERIALS AS SHOWN ON THE ELEVATION.
 - O. FINISHES TO BE OF THE SAME TYPE AND MATERIALS AS SHOWN ON THE ELEVATION.
 - P. FINISHES TO BE OF THE SAME TYPE AND MATERIALS AS SHOWN ON THE ELEVATION.
 - Q. FINISHES TO BE OF THE SAME TYPE AND MATERIALS AS SHOWN ON THE ELEVATION.
 - R. FINISHES TO BE OF THE SAME TYPE AND MATERIALS AS SHOWN ON THE ELEVATION.
 - S. FINISHES TO BE OF THE SAME TYPE AND MATERIALS AS SHOWN ON THE ELEVATION.
 - T. FINISHES TO BE OF THE SAME TYPE AND MATERIALS AS SHOWN ON THE ELEVATION.
 - U. FINISHES TO BE OF THE SAME TYPE AND MATERIALS AS SHOWN ON THE ELEVATION.
 - V. FINISHES TO BE OF THE SAME TYPE AND MATERIALS AS SHOWN ON THE ELEVATION.
 - W. FINISHES TO BE OF THE SAME TYPE AND MATERIALS AS SHOWN ON THE ELEVATION.
 - X. FINISHES TO BE OF THE SAME TYPE AND MATERIALS AS SHOWN ON THE ELEVATION.
 - Y. FINISHES TO BE OF THE SAME TYPE AND MATERIALS AS SHOWN ON THE ELEVATION.
 - Z. FINISHES TO BE OF THE SAME TYPE AND MATERIALS AS SHOWN ON THE ELEVATION.

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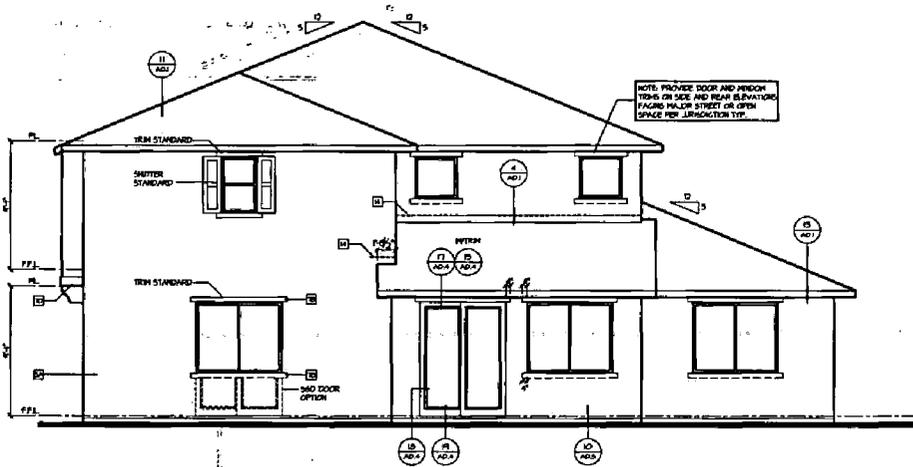
<p>NATOMAS CREEK 65 SACRAMENTO, CA</p>		<p>D-R-HORION America's Builder</p>		<p>4401 Hazel Ave. Ste. 225 Fair Oaks, CA 95628 916-965-2200</p>	
<p>1177 Industrial Way, Suite 112 Sacramento, CA 95833 Phone: 916-941-0260</p>		<p>Office Locations</p> <p>•Dulles •Tampa •Sacramento •Chicago •Plymouth •Other •Columbus •Portland •Boston</p>		<p>PERMIT SET</p>	

Exhibit 7: Elevation B
(Plan 4)

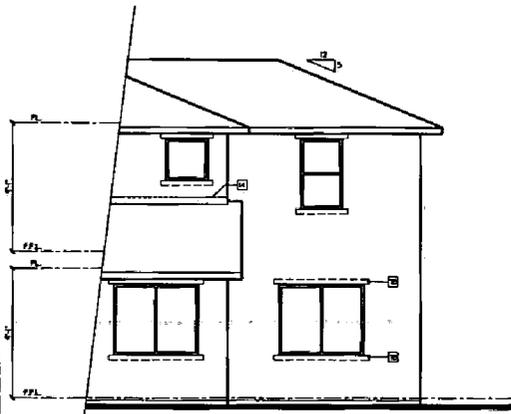

**Bonus Option
Partial Rear Elevation - B**

SCALE: 1/4"=1'-0" 2008-14



Rear Elevation - B

SCALE: 1/4"=1'-0" 2008-14



**Bonus Option
Partial Front Elevation - B**

SCALE: 1/4"=1'-0" 2008-14



**Italian-(Villa Tile)
Front Elevation - B**

SCALE: 1/4"=1'-0" 2008-14

**EXTERIOR
ELEVATION NOTES**

- A. REFER TO GENERAL NOTE SHEETS FOR TYPICAL REQUIREMENTS AND FINISHES, DESCRIPTION OF MATERIALS.
- B. WINDOW HEADS HEIGHTS:
1ST FLOOR = 8'-0" U.S.D. OR EXIST. ELEVATION
2ND FLOOR = 8'-0" U.S.D.
SQUE HEIGHTS AS NOTED ON PLANS (ALSO ADJACENT WINDOW HEADS HEIGHT WITH DOOR HEADS)
- C. EXTERIOR WALLS:
STEECO SYSTEM OVER 1" FOAM INSULATION PER GENERAL NOTES, CORROSION RESISTANT NEW SCARF AT BASE.
- D. EXTERIOR SCOFFS:
STEECO PER GENERAL NOTES
- E. ROOFING:
CLASS 31 FIRE RETARDANT CONCRETE TILES (ELEVATION X) - LOW-PROFILE CONCRETE TILE PER GENERAL NOTES SEE ROOFING DETAILS FOR FINISHES.
ELEVATION Y: LOW-PROFILE CONCRETE TILE PER GENERAL NOTES SEE ROOFING DETAILS FOR FINISHES.
ELEVATION Z: FLAT CONCRETE TILE PER GENERAL NOTES SEE ROOFING DETAILS FOR FINISHES.

ELEVATION KEY NOTES

- 1 STEEKO TRUSS - 7' ROUGH SIZE AS NOTED. SEE DETAILS. DECORATIVE BRACKET FROM HERE SHOWN
- 2 STEEKO GOLF / LON HALL STEEKO OVER FLASHING PLANS. SEE EXTERIOR ELEVATIONS FOR DETAIL
- 3 FLASHING BRACKETS STEEKO OVER FLASHING PLANS. SEE DETAIL WADA.
- 4 ADHERED STONE VENEER AS SELECTED BY BUILDER. HEIGHT AS NOTED. SEE DETAIL.
- 5 A-SIZE OF TYP B-SIZE OF TYP
- 6 ADHERED STONE VENEER TRIM. SEE DETAIL.
- 7 STEEKO OVER FOAM TRIM:
A. FLAT FOAM BY STEEKO OVER
B. FLAT FOAM BY STEEKO OVER
C. FLAT FOAM BY STEEKO OVER
D. FLAT FOAM BY STEEKO OVER
E. 2" FLAT FOAM BY STEEKO OVER
F. 3" FLAT FOAM BY STEEKO OVER
G. 4" FLAT FOAM BY STEEKO OVER
H. 5" FLAT FOAM BY STEEKO OVER
I. 6" FLAT FOAM BY STEEKO OVER
J. 7" FLAT FOAM BY STEEKO OVER
K. SHIPPED FOAM BY STEEKO OVER
- 8 SCORED STEEKO HT.
- 9 DECORATIVE PROMANT BRIM. SEE DETAILS.
- 10 IF HALF ROUND - J. KEEP FL. HERRD PROPORT DECORATIVE GLAZT PRES. SEE ELEVATIONS AND DETAIL. AND L.
- 11 CORROSION RESISTANT SCARF. LOWEST VENT. HEIGHT AS NOTED. SEE EXTERIOR ELEVATION FOR DETAILS.
- 12 FALSE HOOD SHUTTERS. TYPE AS SHOWN. SEE DETAILS B-WADA.
- 13 LOWEST FINISH. SEE DETAIL B-WADA.
- 14 CORROSION RESISTANT ROOF TO HALL FLASHING. SEE ROOF DETAILS.



DATE	DESCRIPTION

4401 Hazel Ave. Ste. 225
Oakland, CA 94612
Fair 918-985-2200

D. RHONON
America's Builder

NATOMAS CREEK 65
SACRAMENTO, CA


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Rec'd 3/2/04


PERMIT SET
1-5-2004

Exhibit 7: Elevation B
(Plan 4)


Bonus Option
Partial Left Elevation - B
SCALE: 1/8" = 1'-0"
DATE: 11/11/04

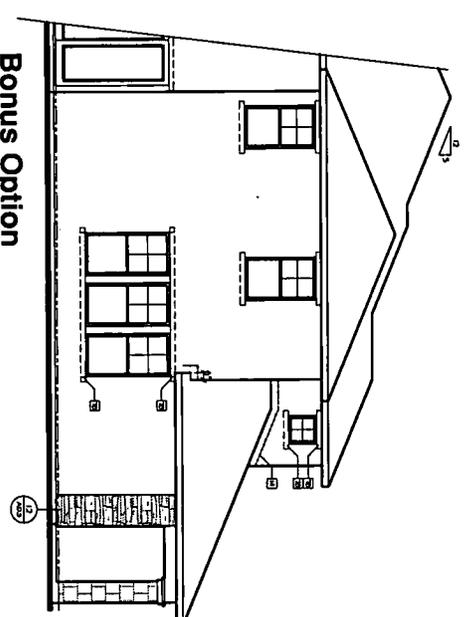

Left Elevation - B
SCALE: 1/8" = 1'-0"
DATE: 11/11/04

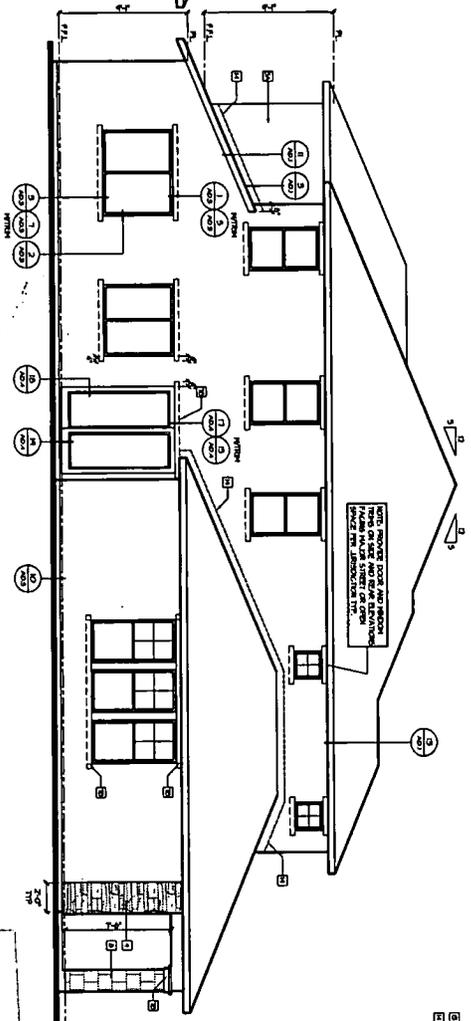

Right Elevation - B
SCALE: 1/8" = 1'-0"
DATE: 11/11/04

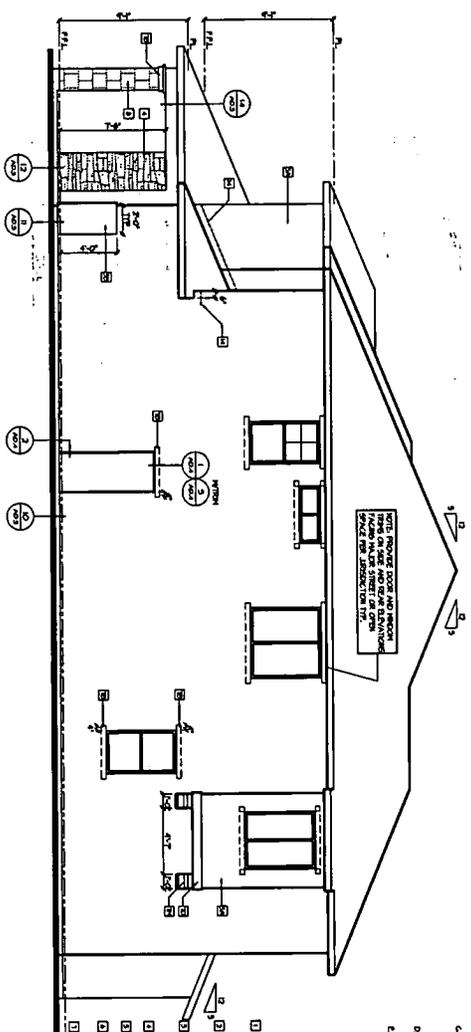


- EXTERIOR ELEVATION NOTES**
1. SEE EXTERIOR FINISH SCHEDULE FOR MATERIALS AND FINISHES.
 2. EXTERIOR ELEVATIONS SHALL BE SHOWN AS APPEARING AT THE TIME OF PERMITS. SEE EXTERIOR ELEVATION FOR DETAIL.
 3. EXTERIOR ELEVATIONS SHALL BE SHOWN AS APPEARING AT THE TIME OF PERMITS. SEE EXTERIOR ELEVATION FOR DETAIL.
 4. EXTERIOR ELEVATIONS SHALL BE SHOWN AS APPEARING AT THE TIME OF PERMITS. SEE EXTERIOR ELEVATION FOR DETAIL.
 5. EXTERIOR ELEVATIONS SHALL BE SHOWN AS APPEARING AT THE TIME OF PERMITS. SEE EXTERIOR ELEVATION FOR DETAIL.
 6. EXTERIOR ELEVATIONS SHALL BE SHOWN AS APPEARING AT THE TIME OF PERMITS. SEE EXTERIOR ELEVATION FOR DETAIL.
 7. EXTERIOR ELEVATIONS SHALL BE SHOWN AS APPEARING AT THE TIME OF PERMITS. SEE EXTERIOR ELEVATION FOR DETAIL.
 8. EXTERIOR ELEVATIONS SHALL BE SHOWN AS APPEARING AT THE TIME OF PERMITS. SEE EXTERIOR ELEVATION FOR DETAIL.
 9. EXTERIOR ELEVATIONS SHALL BE SHOWN AS APPEARING AT THE TIME OF PERMITS. SEE EXTERIOR ELEVATION FOR DETAIL.
 10. EXTERIOR ELEVATIONS SHALL BE SHOWN AS APPEARING AT THE TIME OF PERMITS. SEE EXTERIOR ELEVATION FOR DETAIL.

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Rec'd 3/12/04


NATOMAS CREEK 65 SACRAMENTO, CA 117 Washburn Way, Suite 110 Fair Oaks, CA 95628 Phone: 916-941-2820	D-R HORTON <i>America's Builder</i>	4401 Hazel Ave. Ste. 225 Fair Oaks, CA 95628 916-965-2200
		<p style="text-align: center;">Office Locations</p> <p> <input type="checkbox"/> Anaheim <input type="checkbox"/> Tampa <input type="checkbox"/> Sacramento <input type="checkbox"/> Chicago <input type="checkbox"/> Phoenix <input type="checkbox"/> Dallas <input type="checkbox"/> Denver <input type="checkbox"/> Houston <input type="checkbox"/> Jacksonville <input type="checkbox"/> Orlando <input type="checkbox"/> Boston </p>
Bloodgood Stamp Buster 117 Washburn Way, Suite 110 Fair Oaks, CA 95628 Phone: 916-941-2820	1-5-2004 PERMIT SET	

Exhibit 7: Elevation C
(Plan 4)

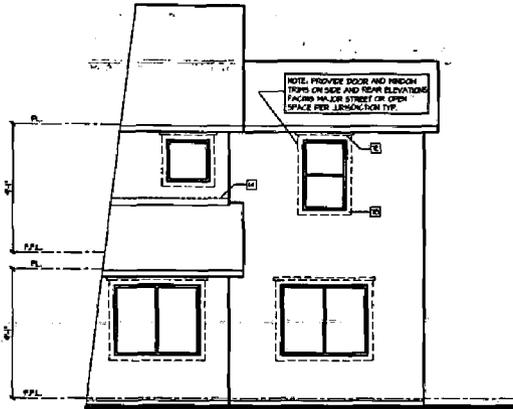


**Bonus Option
Partial Rear Elevation - C**

SCALE: 1/4"=1'-0"

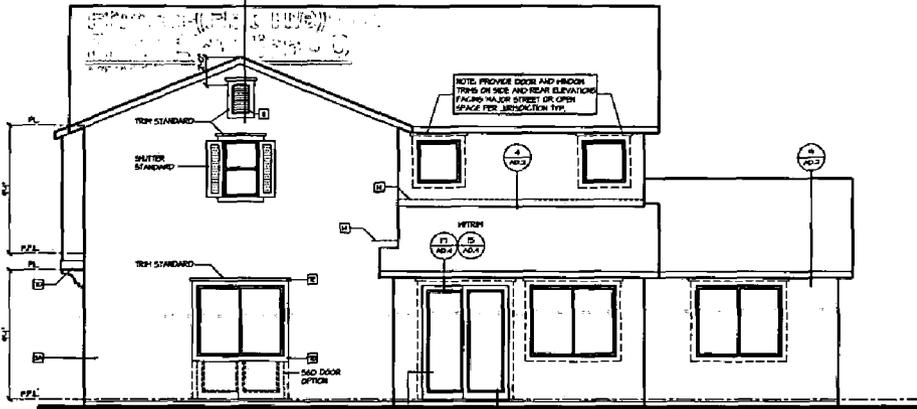


Rear Elevation - C

SCALE: 1/4"=1'-0"

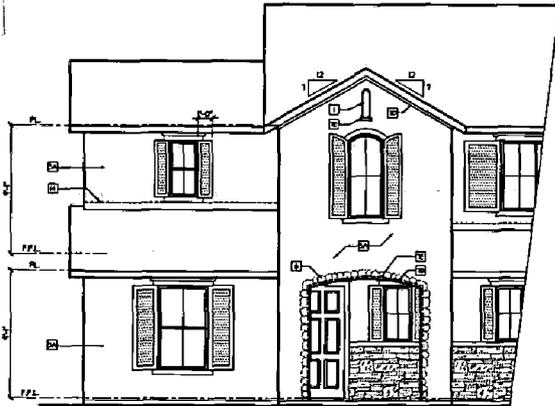

**Bonus Option
Partial Front Elevation - C**

SCALE: 1/4"=1'-0"

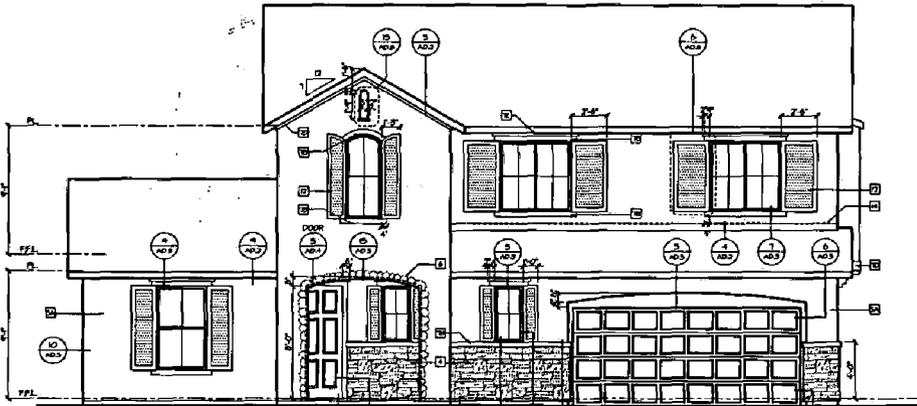

**French-(Flat Tile)
Front Elevation - C**

SCALE: 1/4"=1'-0"

**EXTERIOR
ELEVATION NOTES**

- A. REFER TO GENERAL NOTE SHEETS FOR TYPICAL REQUIREMENTS AND SPECIFIC DESCRIPTIONS OF FINISHES.
- B. WINDOW HEAD HEIGHTS:
-1ST FLOOR = 8'-0" UNLESS NOTED OTHERWISE
-2ND FLOOR = 8'-0" UNLESS NOTED OTHERWISE
-DOOR HEIGHTS AS NOTED ON PLANS
-DIM. ADJUSTMENT WINDOW HEADER HEIGHT PER DOOR HEADERS
- C. EXTERIOR WALLS:
-STRECCO APPLIED OVER 1" FOAM INSULATION PER GENERAL NOTES, CORROSION RESISTANT MESH SCREENED AT BASE.
- D. EXTERIOR SOFFITS:
-STRECCO PER GENERAL NOTES
- E. ROOFING:
-GLASS TILE PER RESTAURANT CONCRETE TILES
-ELEVATION W/1: LOW-PROFILE CONCRETE TILE PER GENERAL NOTES, SEE ROOFING DETAILS FOR FINISHES
-ELEVATION W/2: LOW-PROFILE CONCRETE TILE PER GENERAL NOTES, SEE ROOFING DETAILS FOR FINISHES
-ELEVATION W/3: PLAT CONCRETE TILE PER GENERAL NOTES, SEE ROOFING DETAILS FOR FINISHES

ELEVATION KEY NOTES

- 1. STRECCO BRICKS - 3" FROM SIDE AS NOTED, SEE DETAILS. DECORATIVE PRISMATIC BRICK MORE SHOWN EXTERIOR ELEVATIONS FOR DETAIL.
- 2. STRECCO SHELF / LUSH WALL STRECCO OVER ELASTOMERIC FLASHING, SEE EXTERIOR ELEVATIONS FOR DETAIL.
- 3. SLOPING SURFACE STRECCO OVER ELASTOMERIC FLASHING, SEE DETAIL.
- 4. ADHERED STONE VENEER AS INDICATED BY DIMENSION, HEIGHT AS NOTED, SEE DETAIL.
- 5. A. STRECCO 1/2" TYP
B. STRECCO 1/2" TYP
- 6. ADHERED STONE VENEER TYP, SEE DETAIL.
- 7. STRECCO OVER FOAM TRIM
A. 1/2" FOAM IN STRECCO OVER
B. 1/2" FOAM IN STRECCO OVER
C. 3/4" FOAM IN STRECCO OVER
D. 1" FOAM IN STRECCO OVER
E. 1 1/2" FOAM IN STRECCO OVER
F. 2" FOAM IN STRECCO OVER
G. 3" FOAM IN STRECCO OVER
H. 4" FOAM IN STRECCO OVER
I. 6" FOAM IN STRECCO OVER
J. 8" FOAM IN STRECCO OVER
K. 10" FOAM IN STRECCO OVER
L. 12" FOAM IN STRECCO OVER
M. SHIMMED FOAM IN STRECCO OVER
- 8. SCORED STRECCO - 1/2"
- 9. DECORATIVE PRISMATIC BRICK, SEE DETAILS.
- 10. 6" HALF ROUND 1/2" DEEP ALUMINUM MOUNTED DECORATIVE GLAZ PIPES, SEE ELEVATIONS AND REAR ELEVATION.
- 11. CORROSION RESISTANT SCREEN LOUVERED VENT 1/2" UNLESS NOTED, SEE EXTERIOR ELEVATION FOR DETAILS.
- 12. FALM WOOD SHUTTERS, TYPE AS SHOWN, SEE DETAILS 5-10A-D.
- 13. LOUVERED FINISH, SEE DETAIL, SHADA.
- 14. CORROSION RESISTANT ROOF TO WALL FLASHING, SEE ROOF DETAILS.



4401 Hazel Ave. Ste. 225
Fair Oaks, CA 95628
916-985-1200

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America's Builder


NATOMAS CREEK 65
SACRAMENTO, CA

PLAN 4
SHEET NO. A3.9


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Rec'd 3/2/04


Exhibit 7: Elevation C
(Plan 4)

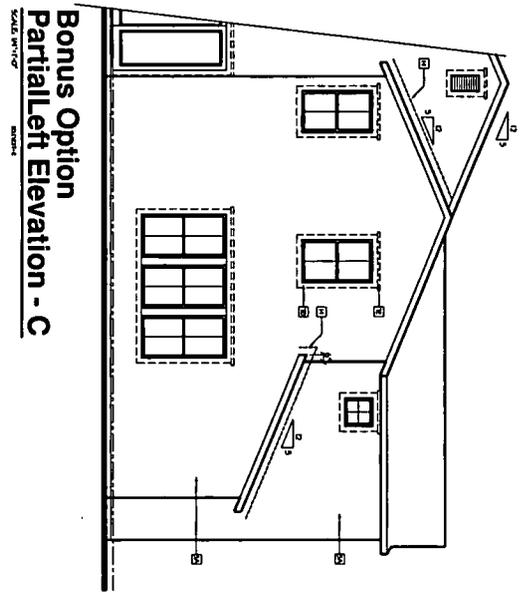


Bonus Option
Partial Left Elevation - C

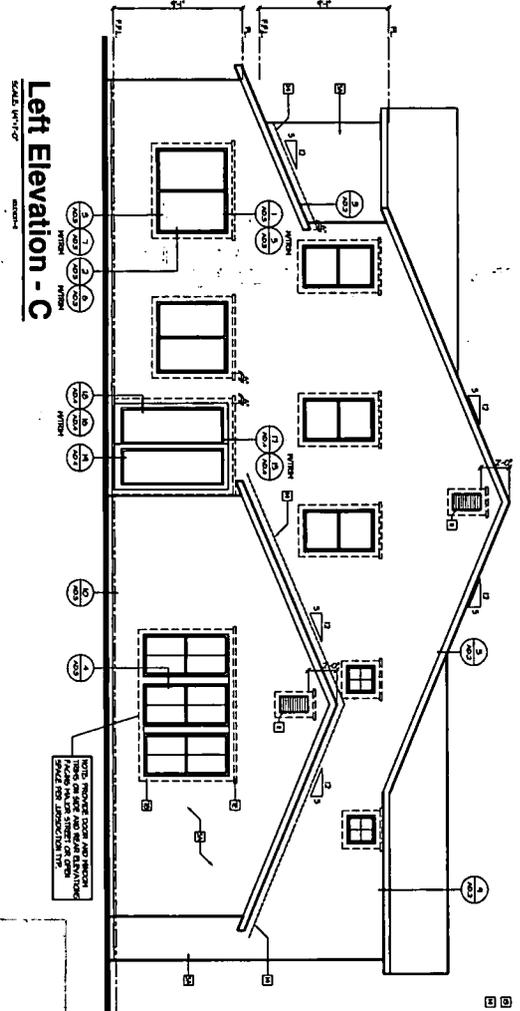

Left Elevation - C

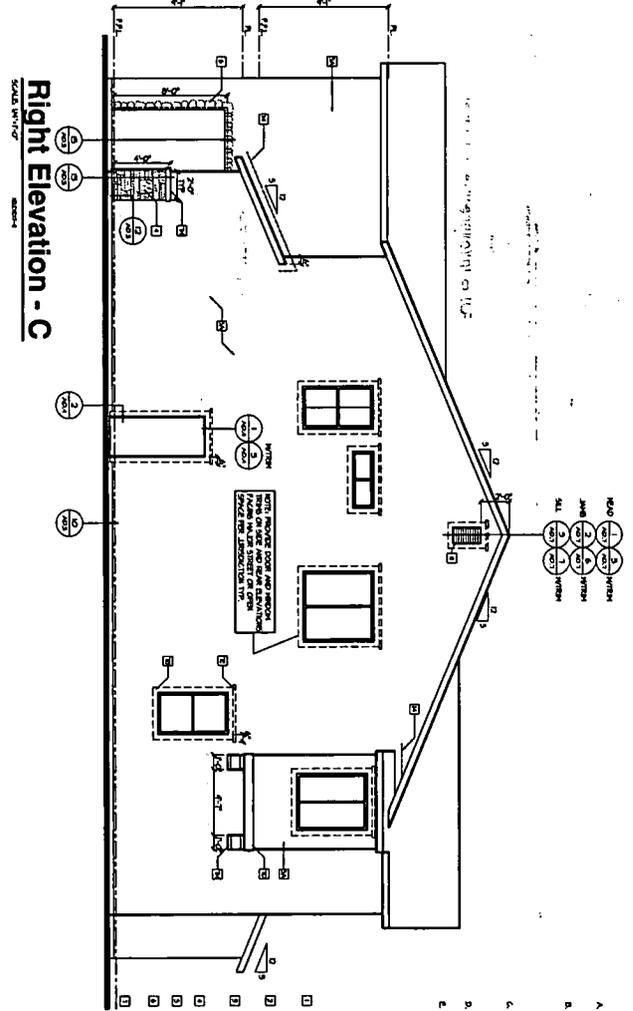

Right Elevation - C


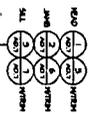


- EXTERIOR ELEVATION NOTES**
1. REFER TO GENERAL NOTES SHEETS FOR THIS EXTERIOR ELEVATION AND SYMB.
 2. REFER TO GENERAL NOTES SHEETS FOR THIS EXTERIOR ELEVATION AND SYMB.
 3. REFER TO GENERAL NOTES SHEETS FOR THIS EXTERIOR ELEVATION AND SYMB.
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 9. REFER TO GENERAL NOTES SHEETS FOR THIS EXTERIOR ELEVATION AND SYMB.

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Rec'd 3/2/04

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<p>117 Woodland Way, Suite 110 D River Hill, CA 95742 Phone: 916-941-0880</p>		<p>Office Locations</p> <p>•Oak Ridge •Tampa •Sacramento •Chicago •Phoenix •Dallas •Crestview •Jacksonville •Orlando •Atlanta</p>		<p>1-5-2004 PERMIT SET</p>	

Exhibit 8: Model Homes Staking and Paving Plan

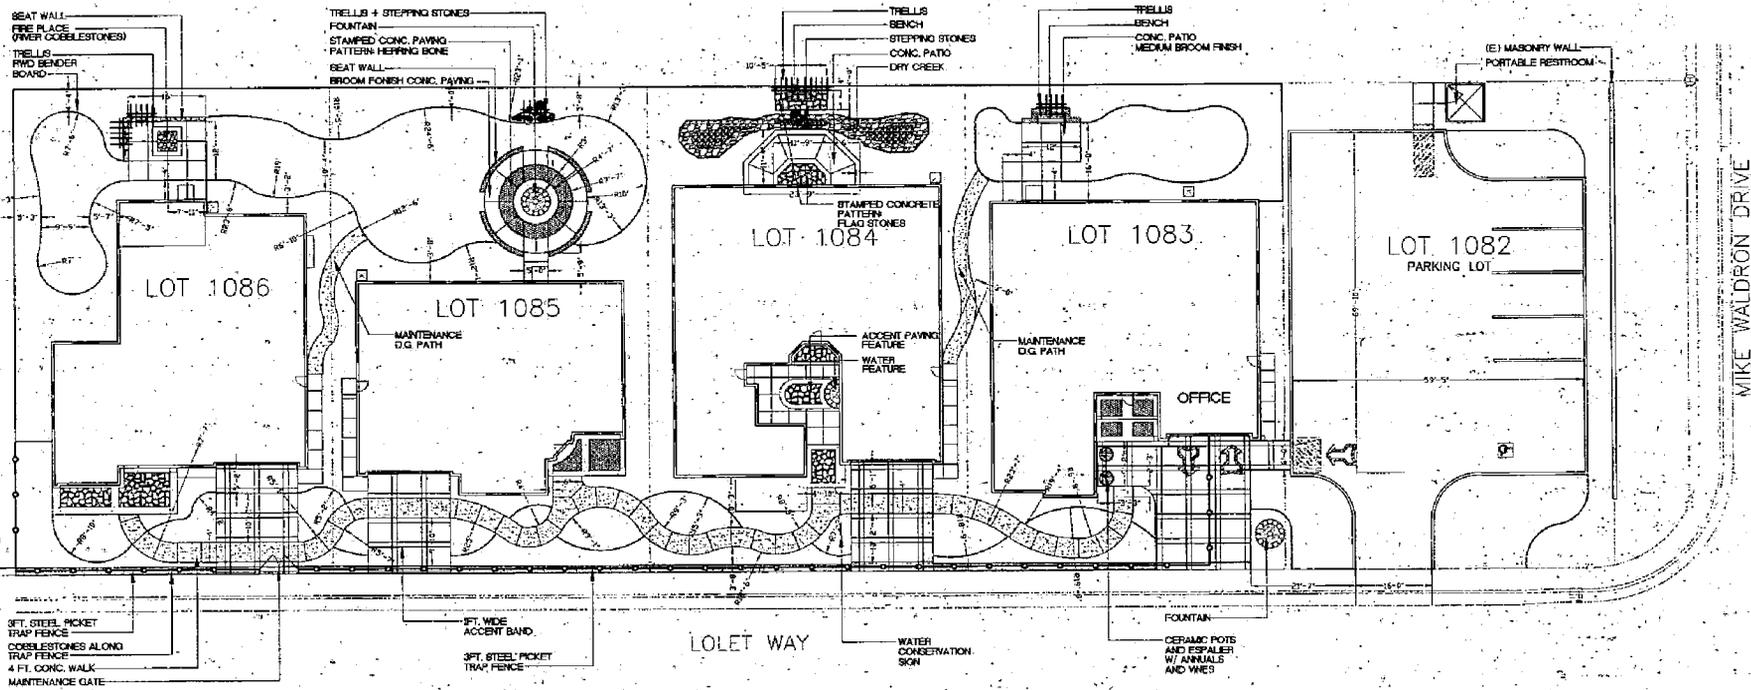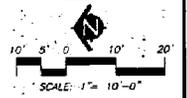

PAVING AND SITE LEGEND

KEY	KEY	KEY	KEY
			WOOD TRELLIS
			ESPALIER
			6 FT. WOOD BENCH COORDINATE TYPE W/ OWNER
			WATER FOUNTAIN COORDINATE TYPE W/ THE OWNER

MTW group
 MEMPHYS
 TOKESHVILI
 WERNIETSKI

LANDSCAPE ARCHITECTURE
 AND PLANNING
 10411 Old Placerville Road,
 Suite 205
 Sacramento, CA 95827
 916 369-3990


DATE APRIL 21 2004
 JOB NO. 04-032
 SHEET TITLE
SRTAKING AND PAVING PLAN
 SHEET NO. L1
 SHEET 1 OF 3 TOTAL

STERLING HILLS AT NATOMAS CREEK
 MODEL HOMES
 SACRAMENTO, CALIFORNIA

D.R. HORTON, INC.
 4401 HAZEL AVENUE, SUITE 226
 FAIR OAKS, CALIFORNIA 95628
 (916) 865-2200

P04-037
 Rec'd 5/6/04

Exhibit 9: Model Homes Tree Planting Plan

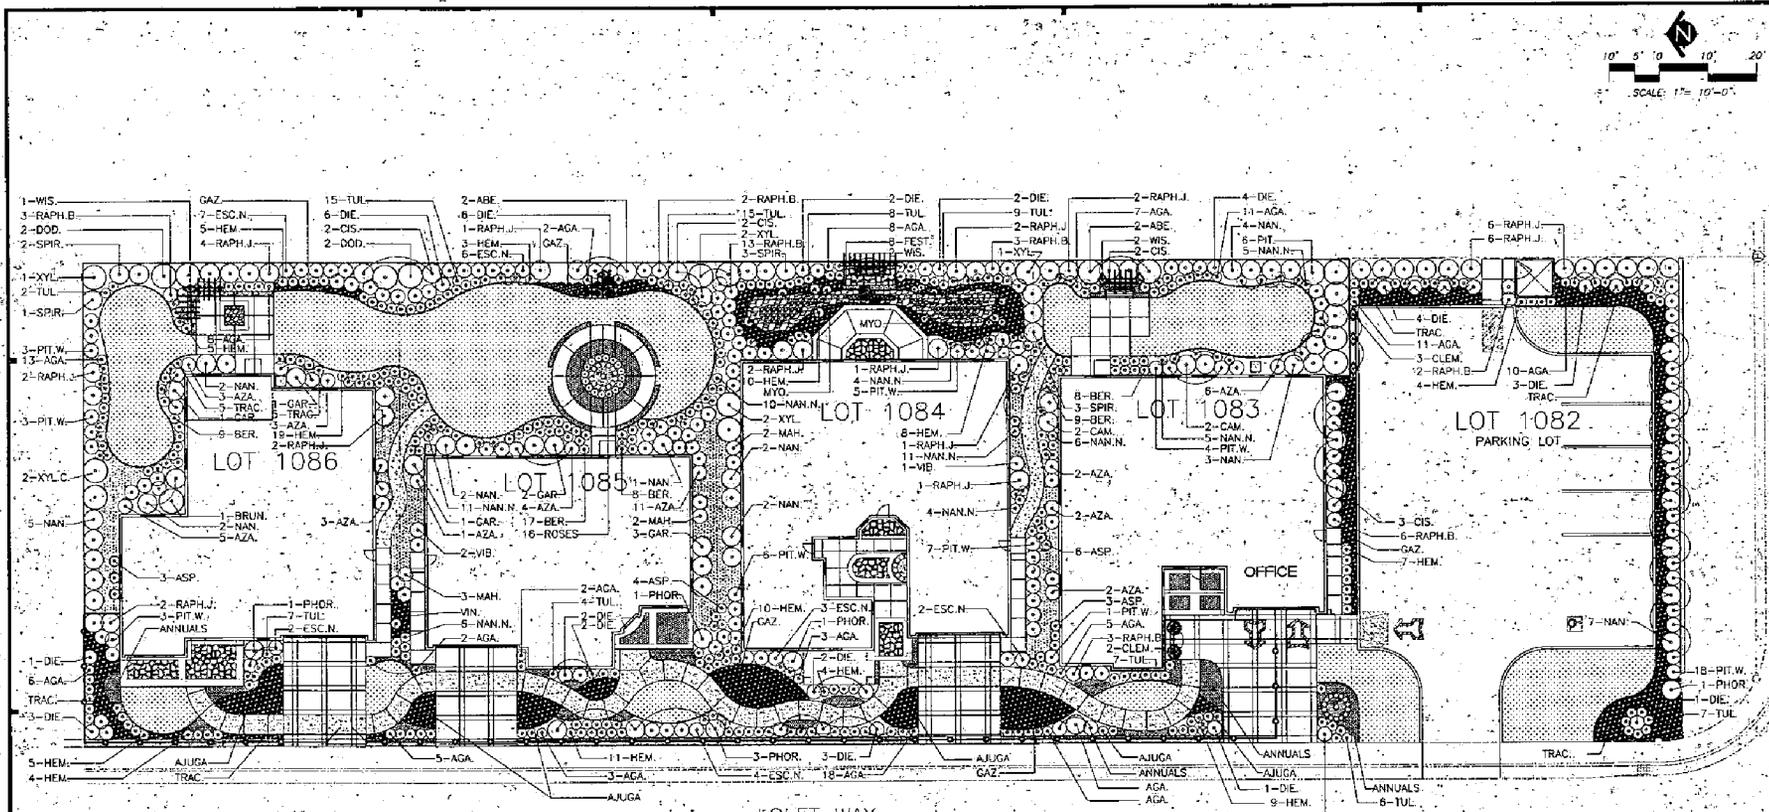

LOT 1084
LOT 1083
LOT 1082
LOT 1086
OFFICE
PARKING LOT
LOT WAY
PLANT MATERIAL LIST

SIZE	QUANTITY	KEY	BOTANICAL NAME - COMMON NAME ?
SHRUBS			
5 0.C.	4	ABE	ABELIA GRANDIFLORA "SHERWOOD" ... "GLOSSY ABELIA"
1 0.C.	14	AGA	ADAPANTHUS AFRICANUS "PETER PAN" ... "DWARF LILY-OF-THE-VALLEY"
5 0.C.	16	ASP	ADONISMA FLAVIB ... OXI-IRON PLANT
5 0.C.	42	AZA	AZALEA BELGIAN INDICA ... BELGIAN INDICA AZALEA
1 0.C.	51	BER	BELGIANA CRISPOBOLIA ... WINTER-BLOOMING BERGEMIA
5 0.C.	1	BRUN	BRUNFELSIA FLO-BLUNDA ... YESTERDAY-TODAY & TOMORROW
5 0.C.	4	CAM	CAMELLIA SASANQUA "YULETIDE" ... CAMELLIA
1 0.C.	18	FEST.	TESTUDINA OVINA "OLGA" ... BLUE TESTUDO
5 0.C.	9	ESC	CISTUS PURPUREUS ... ORCHID ROCKROSE
5 0.C.	45	DIE	DIETES BICOLOR ... "DORNBIGHT LILY"
5 0.C.	14	DZD	DZODENIA YASOGIA "SANTOCHA" ... HOOP BUSH
5 0.C.	24	ESC.N	ESCALONIA RUBRA "NEWPORT DWARF" ... DWARF ESCALLONIA
1 0.C.	8	GAR	GARDENIA JASMINOIDES "VETCHI" ... GARDENIA
5 0.C.	99	HEM	HEMERALES HYBRIDS ... DANIELI
5 0.C.	7	MAH	MADONIA NERVOSA ... LONGLEAF MADONIA
5 0.C.	62	MAW	MADONIA DOMESTICA "HARBOR DWARF" ... DWARF HEAVENLY BAMBOO
5 0.C.	30	MAW	MADONIA DOMESTICA ... HEAVENLY BAMBOO
5 0.C.	9	SPAR	SPIREA THUNBERGII "OOGON" ... MELLOW YELLOW SPIREA
5 0.C.	8	PHOR	PHODOSPERM TENAX "TOM THUMB" ... DWARF NEW ZEALAND FLAX
5 0.C.	30	PIT.W	PITOSPORUM TOBIIRA "WHELLEN'S DWARF" ... DWARF PITOSPORUM
5 0.C.	5	PIT	PITOSPORUM TOBIIRA "VARIEGATA" ... VARIEGATED TOBIIRA
5 0.C.	5	RAPH.B	RAPHANOPSIS INDICA "SALLEENA" ... DWARF INDIA HAWTHORN
5 0.C.	12	RAPH.J	RAPHANOPSIS INDICA "JACK EVANS" ... DWARF INDIA HAWTHORN
1 0.C.	10	TRAC	TRACHELOSPERMUM JASMINOIDES "STAR JASMINE"
1 0.C.	80	TUL	TULBAGHIA NIVALEA "SOCIETY GARLIC"
5 0.C.	8	XYL	XYLOSIA CONGESTUM ... XYLOSIA
5 0.C.	2	VB	VELURIUM DAVIDI ... VIBURNUM
5 0.C.	16	ROSES	MULTI-COLORED ROSES
GROUNDCOVER			
FLATS	12' 0.C.	AJUGA	AJUGA REPTANS "PURPUREA" ... CARPET BUGLE
FLATS	18' 0.C.	GAZ	GRABARA VIVIPARUS "SEA-DOR" ... TREMBLING GRABARA
1 0.C.	24' 0.C.	MAW	TRACHELOSPERMUM JASMINOIDES "STAR JASMINE"
1 0.C.	24' 0.C.	MAW	VINCA MINOR ... DWARF PERIWINKLE
1 0.C.	35' 0.C.	MYO	MYOPORUM PARFOLIUM ... MYOPORUM
VINES			
1 0.C.	5	CLE	CLEMATIS ARMANDI ... EVERGREEN CLEMATIS
1 0.C.	5	WIS	WISTERIA SINENSIS ... CHINESE WISTERIA

KEY LANDSCAPE LEGEND

- SHRUBS
- BARK MULCH
- GROUNDCOVER
- ANNUALS
- LAWN - SOO
- RWD HEADER BOARD
- PLANT QUANTITY
- PLANT KEY

LANDSCAPE NOTES

- NO PLANTING SHALL BE STARTED UNTIL SPRINKLER IRRIGATION SYSTEM HAS BEEN TESTED BY CONTRACTOR IN PRESENCE OF OWNER'S REPRESENTATIVE AND NOTED DEFICIENCIES CORRECTED. EXCEPTION: DRIP IRRIGATION FOR SHRUBS.
 - NO PLANTING SHALL BE STARTED UNTIL SOIL PREPARATION AND FINISH GRADING OPERATIONS HAVE BEEN COMPLETED AND APPROVED BY THE OWNER'S REPRESENTATIVE.
 - QUANTITIES SHOWN ON PLANT MATERIAL LIST ARE APPROXIMATE. PROVIDE QUANTITIES INDICATED ON LANDSCAPE PLAN.
 - PLANT MATERIAL IS SUBJECT TO APPROVAL OF OWNER'S REPRESENTATIVE.
 - FOR LANDSCAPE AND SPRINKLER IRRIGATION DETAILS, SEE SHEET L3.1 AND L6.1.
 - INSTALL BARK MULCH IN ALL EXPOSED "DIRT" AREAS.
 - INSTALL BARK MULCH TO ALL SHRUB PLANTING AREAS AND AS PER NOTE NO. 18.
- NOTE:**
FOR SOIL ANALYSIS REPORT AND WATER USE CALCULATIONS, SEE SHEET L4.1.

MTW group
Landscape Architecture and Planning
10411 Old Placerville Road, Suite 205
Sacramento, CA 95827
916.369.3990

REVISIONS

NO.	DESCRIPTION	DATE	BY

INITIAL BOX

NO.	DATE	DATE	REVIEWED

STERLING HILLS AT NATOMAS CREEK
MODEL HOMES
SACRAMENTO, CALIFORNIA

D.R. WORTON, INC.
4401 HAZEL AVENUE, SUITE 225
FAIR OAKS, CALIFORNIA 95628
(916) 905-2200

DATE APRIL 21 2004
JOB NO. 04-032
SHEET TITLE TREE PLANTING PLAN
SHEET NO. L21
SHEET 3 OF 10 TOTAL

P04-037
Rec'd 5/6/04

CITY OF SACRAMENTO
WATER USE CALCULATIONS

WATER USE	PLANT	SQ. FT.	WATER USE FACTOR (TOTAL SQ. FT. X USE FACTOR)
LOW	ADAPANTHUS	96	767.5 x (0.4) = 307.0
	DIETES	35	
	PAZONIA	214	
	HYDRORUM	209	
	MAHONIA	14	
	IRAPHOLEPIS	199.5	
	TULBAGHIA	51	
	XYSOXA	78	
MEDIUM	LAURUS	45	510 x 1.0 = 510.0
	ESCALONIA	35	
	HEMEROCALLIS	89	
	IRACONIA	113	
	PHORNIUM	29	
	PITIOSPORUM	126	
	SPIREA	75	
	YBURNUM	7	
TOTALS		1277.5 SF	812.0 SF

LIST	GALLONS/WEEK * SUMMER ESTABLISHMENT	ESTABLISHMENT				MAINTENANCE			
		SP	SM	IF	W	SP	SM	F	W
DRIP B1 1,966GPM	199.2GPM	1	2	1	0	1	2	1	1
DRIP B2 2,496GPM	295.2GPM	1	2	1	0	1	2	1	1
DRIP B3 2,095GPM	247.2GPM	1	2	1	0	1	2	1	1
MICRO B4 1,976GPM	118.2GPM	3	4	2	0	3	4	2	1
TOTAL WATER USAGE PER WEEK = 859.6 GALLONS PER WEEK									
TOTAL WATER USAGE PER YEAR = 30952.8 GALLONS									

WATER USE CALCULATIONS
MAXIMUM APPLIED WATER ALLOWANCE (MAWA)
= (ET0) (0.8) (TOTAL PROJECT AREA) (0.82)
= (51.9) (0.8) (1277.5) (0.82)
= 32,885.9 GAL/YEAR

ESTIMATED APPLIED WATER USE (EAWU)
30952.8 GAL/YEAR (SEE IRRIGATION SCHEDULE)

EAWU (30952.8 GAL/YEAR) < MAWA (32885.9 GAL/YEAR)

Exhibit 10: Irrigation Schedule and Calculations

MTW group
Landscape Architecture and Planning
10411 Old Placerville Road
Suite 209
Sacramento, CA 95827
916 369-1990

CONSULTANTS

NO.	DESCRIPTION	DATE REV.

INITIAL BOX

NO.	DATE	REVIEWED

Sunland Analytical
11311 Peyton Way, Suite 4
Rancho Cordova, CA 95670
(916) 871-8337

RECEIVED
APR 26 2004
Date Reported: 04/23/2004
Date Submitted: 04/23/2004

Information requested by: **Bob Takahara**
Client: **MTW Group**
Sample ID: **NATOMAS CREEK**

SOIL RECOMMENDATIONS FOR LANDSCAPE SCHEDULING

SOIL pH (Acidity and Alkalinity)
The pH of this sample indicates the soil is in a range for normal growth of most plants. No modification is required.

DISSOLVED SALTS (Indicated by EC & SAR)
These conditions are in the normal range for plant growth.

SOIL PERMEABILITY AND RATE OF WATER INFILTRATION
The infiltration rate for all soil textures decreases with increasing ground slope. At 0 to 4%, 5 to 24%, 25 to 34%, and above 34% the infiltration rate of this sample decreases from 0.25 to 0.20, 0.15, 0.10, 0.06, respectively. Infiltration rate also decreases with percent of ground cover and by compaction.

NAVEY PENETRATION OF SOIL DUE TO CHEMICAL CHARACTERISTICS
When exchangeable sodium increases in the soil, water penetration decreases. Based on SAR and ESP values this sample has no penetration problem due to soil sodium. No gypsum required.

ORGANIC MATTER
Organic matter provides a slow nitrogen release and aids water retention. This sample has a moderate organic matter content. To maintain moisture and provide sustained nitrogen release a level of 10% organic matter is recommended. The amending material that is approximately 75% organic matter (i.e., many ground fir barks). Based on the analysis of this soil sample apply 2 yards per 1000 sq. ft. Spread evenly and blend into the top 2-3 inches of soil. It is a reasonable practice to apply a top dressing of 2 inches of organic mulch to aid water penetration and retention.

SOIL BORON
Boron concentrations are in a range allowing normal plant growth.

Soil Texture: Clay Loam

Element	Concentration	Units
Micro	0.13	ppm
Phosphorus	8.78	ppm
Potassium	232.66	ppm
Sulfur	8.96	ppm
Chloride	90	ppm
Carbonates	90	ppm
Sodium	274.25	ppm
Calcium	3223.18	ppm
Magnesium	1890.82	ppm
Boron	0.42	ppm
Copper	90	ppm
Iron	90	ppm
Manganese	90	ppm
Zinc	90	ppm

Sunland Analytical
11311 Peyton Way, Suite 4
Rancho Cordova, CA 95670
(916) 871-8337

RECEIVED
APR 26 2004
Date Reported: 04/23/2004
Date Submitted: 04/23/2004

Information requested by: **Bob Takahara**
Client: **MTW Group**
Sample ID: **NATOMAS CREEK**

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Sunland Analytical
11311 Peyton Way, Suite 4
Rancho Cordova, CA 95670
(916) 871-8337

RECEIVED
APR 26 2004
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Iron	90	ppm
Manganese	90	ppm
Zinc	90	ppm









SOIL ANALYSIS

STERLING HILLS AT NATOMAS CREEK
MODEL HOMES
SACRAMENTO, CALIFORNIA


D.R. HORTON, INC.
4401 HAZEL AVENUE, SUITE 225
FAIR OAKS, CALIFORNIA 95628
(916) 865-2200

DATE: APRIL 21 2004
JOB NO.: 04-032
SHEET TITLE: IRRIGATION SCHEDULE WATER USE CALCULATION AND SOIL ANALYSIS
SHEET NO.: L4.1
SHEET 3 OF 8 TOTAL

P04-037
Rec'd 5/6/04

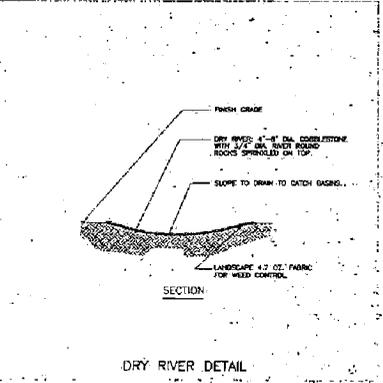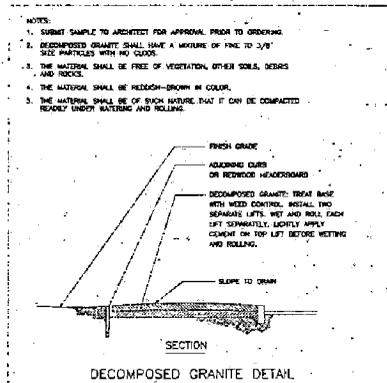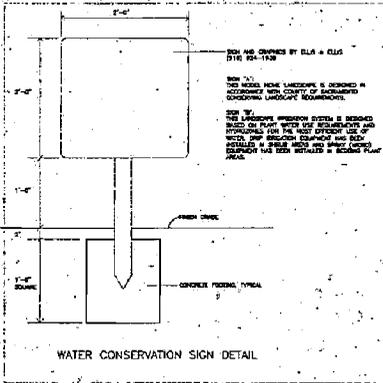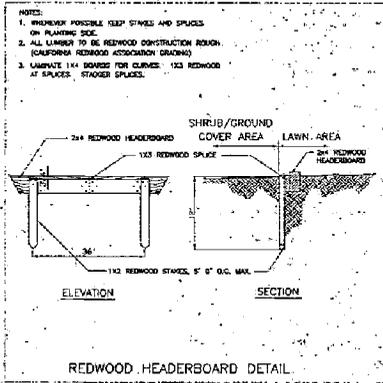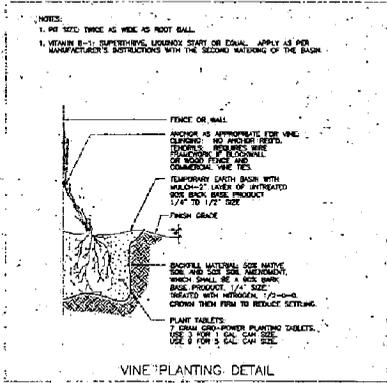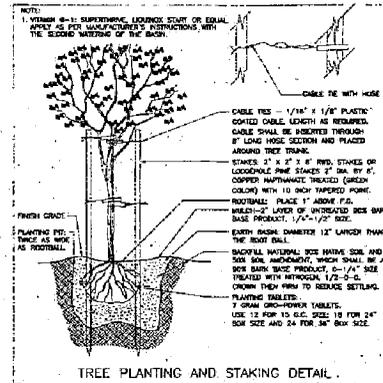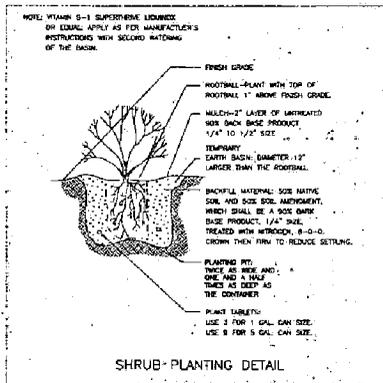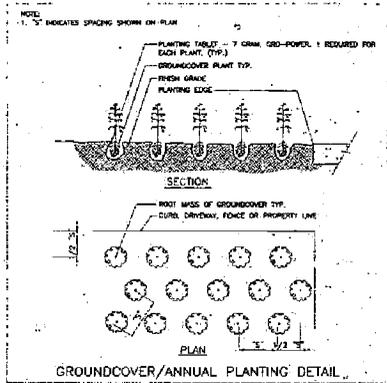

P04-037
Rec'd 5/6/04

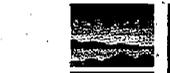

MTW group
Memuyoc
Takahara
Wernicke

LANDSCAPE ARCHITECTURE
AND PLANNING
1041 Old Placerville Road
Suite 205
Sacramento, CA 95827
916 308-1800



D.R. Horton, Inc.
1041 Old Placerville Road
Suite 205
Sacramento, CA 95827
916 308-1800

CONSULTANTS

REVISIONS

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INITIAL BOX

NO.	DATE	RECEIVED

**STERLING HILLS AT NATOMAS CREEK
MODEL HOMES
SACRAMENTO, CALIFORNIA**
D.R. HORTON, INC.
4401 HAZEL AVENUE, SUITE 225
FAIR OAKS, CALIFORNIA 95828
(916) 965-2200

DATE: APRIL 21 2004

JOB NO. 04-032

SHEET TITLE








**PLANTING
DETAILS**

SHEET NO.

L51

SHEET # OF # TOTAL

Exhibit 12: Sprinkler Irrigation Details

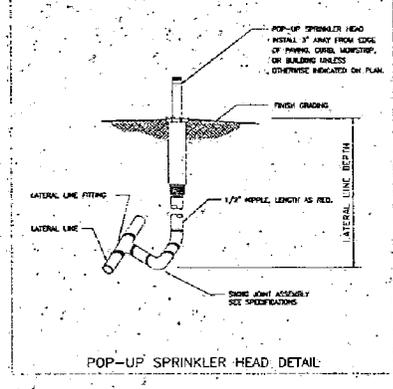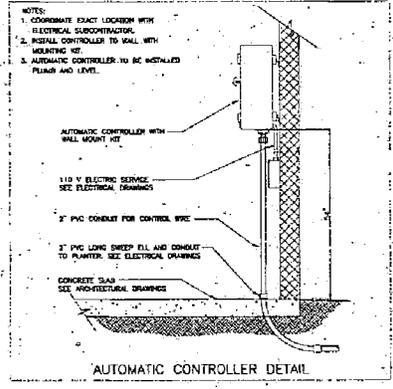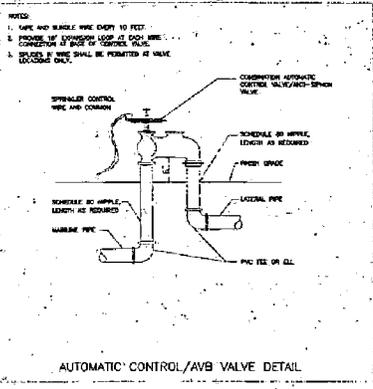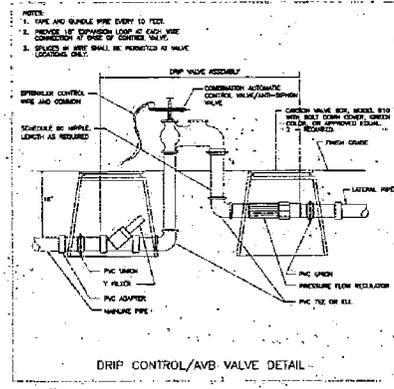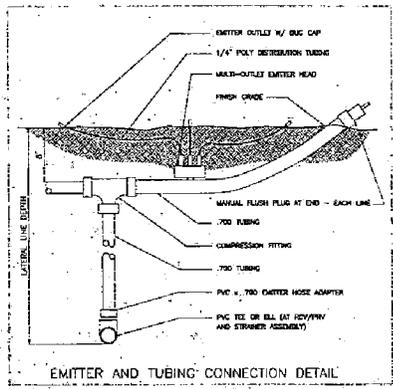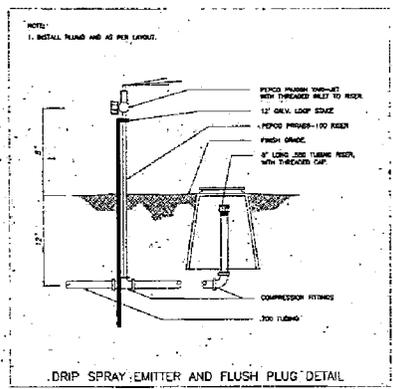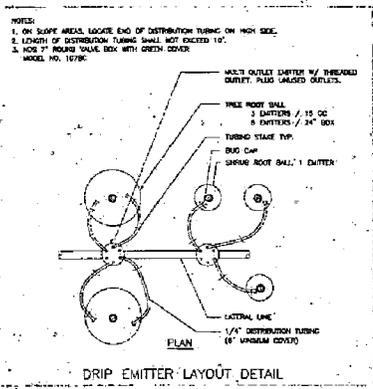

MTWgroup
 Momyrac
 Tolbert
 Woronicki

LANDSCAPE ARCHITECTURE
 AND
 PLANNING
 10411 Oak Reserve Road
 Suite 205
 Sacramento, CA 95827
 916 369-3300

CONSULTANTS

NO.	DESCRIPTION	DATE	REV.

REVISIONS

NO.	DESCRIPTION	DATE	REV.

INITIAL BOX

NO.	DATE	REVISION



**STERLING HILLS AT NATOMAS CREEK
 MODEL HOMES
 SACRAMENTO, CALIFORNIA**

D.R. HORTON, INC.
 4401 HAZEL AVENUE, SUITE 225
 FAIR OAKS, CALIFORNIA 95628
 (916) 985-2280

P04-037
 Rec'd 5/6/04

DATE APRIL 21 2004
 JOB NO. 04-032
 SHEET TITLE
SPRINKLER IRRIGATION DETAILS
 SHEET NO.
L61
 SHEET 7 OF 10 TOTAL

Exhibit 13: Trellis and Wood Screen Details

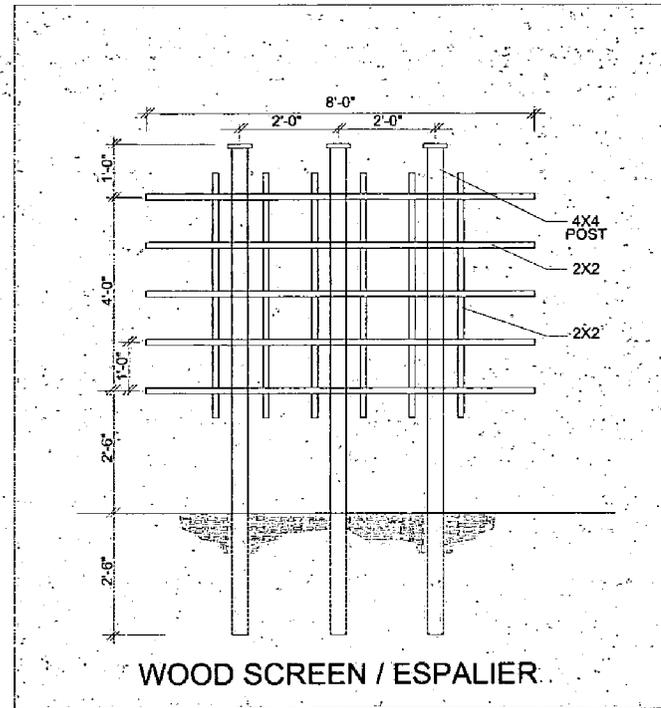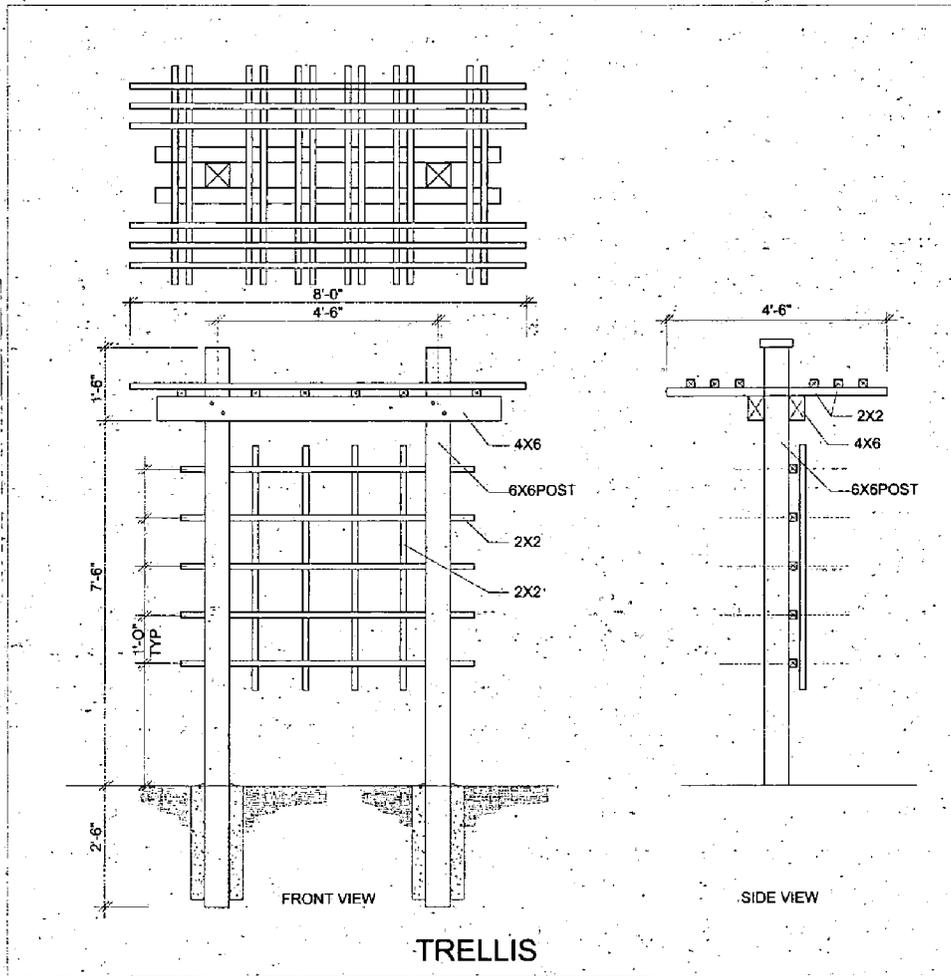

P04-037
Rec'd 5/6/04



MTWgroup
M E M U Y O C
T A K A H O R O
W A R O T S C H E K I

LANDSCAPE ARCHITECTURE
AND PLANNING
10411 Old Placerville Road
Suite 205
Sacramento, CA 95827
916 362-3990



200 License C-301

CONSULTANTS

REVISIONS

NO.	DESCRIPTION	DATE	REV.

INITIAL BOX

NO.	DRG. ST.	DATE	REVISION

STERLING HILLS AT NATOMAS CREEK
MODEL HOMES
SACRAMENTO, CALIFORNIA

D.R. HORTON, INC.
4401 HAZEL AVENUE, SUITE 225
FAIR OAKS, CALIFORNIA 95628
(916) 985-2800

DATE: APRIL 21 2004

JOB NO. 04-032

SHEET TITLE



TRELLIS
AND
WOOD SCREEN
DETAILS

SHEET NO.

L71

SHEET 8 OF 10 TOTAL

Exhibit 14: Fountain and Seat
Walls Details

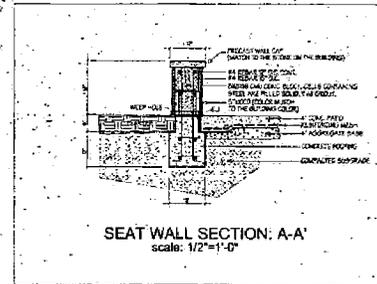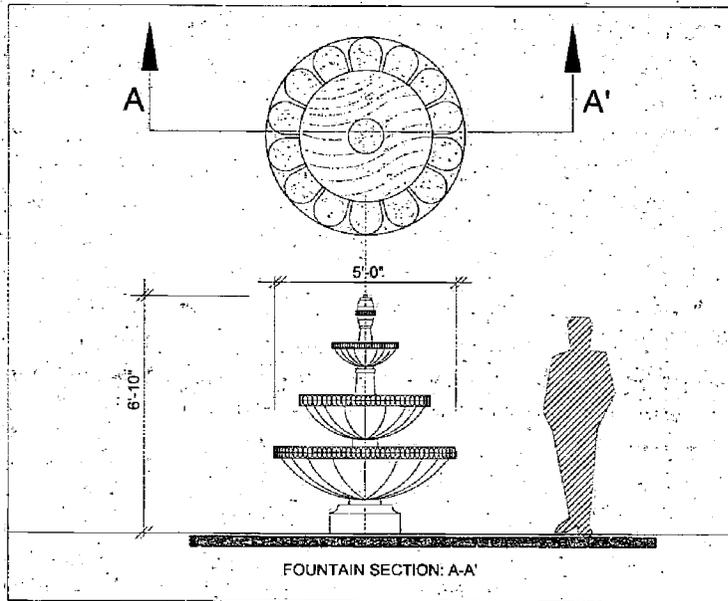

P04-037
Rec'd 5/6/04

MTW
group
M o n t e y e c
T e h o m a s
W a r n i c k

LANDSCAPE ARCHITECTURE
AND PLANNING
10411 Old Placerelle Road
Suite 205
Sacramento, CA 95827
916 359-3520

CONSULTANTS

REVISIONS		
NO.	DESCRIPTION	DATE

INITIAL BOX			
NO.	DRAWN BY	DATE	DATE

STERLING HILLS AT NATOMAS CREEK
MODEL HOMES
SACRAMENTO, CALIFORNIA

D.R. HORTON INC. SUITE 225
FAIR OAKS, CALIFORNIA 95628
(916) 865-2200

DATE APRIL 21 2004

JOB NO. 04-037

SHEET TITLE
FOUNTAIN
AND
SEAT WALL
DETAILS

SHEET NO.

L8.1

SHEET 9 OF 10 TOTAL

LAW OFFICES OF
GREGORY D. THATCH

1730 I Street, Suite 220
SACRAMENTO, CA 95814-3017
Telephone (916) 443-6956
Facsimile (916) 443-4632
E-mail: thatchlaw.com

GREGORY D. THATCH
LARRY C. LARSEN
MICHAEL DEVEREAUX
DAVID P. TEMBLADOR

WASHINGTON, DC OFFICE
1225 I Street, Suite 500
WASHINGTON, DC 20005-3914
Telephone (202) 682-4735
Facsimile (202) 289-8683

February 11, 2004

VIA FACSIMILE AND FIRST CLASS MAIL

Cori Van Dyck
D.R. Horton
4401 Hazel Avenue, Suite 225
Fair Oaks, CA 95628

Re: Natomas Creek PUD / Architectural Reviews

Dear Ms. Van Dyck:


We write to you on behalf of our client, Kern Schumacher, and in response to your request for review and approval of the proposed house plans and elevations presented in your application for a Planning Director Special Permit with the City of Sacramento.

Specifically, our client has reviewed the "Sterling Hill," "Monaco," "Palisades," and "Terrace Park" product lines and approves of their use on the lots identified on the attached exhibit provided by your office.

Per your request, we will be returning the color samples provided for review under separate cover. Thank you for your cooperation in this matter. If we can be of any further assistance, please feel free to contact our office at your convenience.

Very truly yours,

LAW OFFICES OF
GREGORY D. THATCH

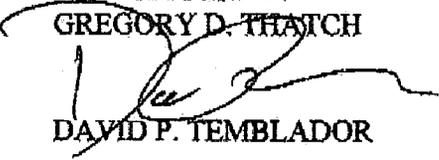
DAVID P. TEMBLADOR

DTNkr
DT0420.ltr
enclosure

cc: Brad Ross

P04-037
2-20-04

**PLANNING DIRECTOR'S SPECIAL PERMIT
FOR SINGLE FAMILY RESIDENTIAL IN A PUD
LETTER OF AGREEMENT**

P04-037: D.R. HORTON - STERLING HILLS AT NATOMAS CREEK

PROJECT NAME/FILE #: Sterling Hills at Natomas Creek, 128 single-family units total, file P04-037

PROJECT LOCATION: Southwest of Elkhorn Boulevard and East Commerce Way in North Natomas

ASSESSOR'S PARCEL NUMBER(S): 201-0300-026, -029

ZONING: R-1-PUD

APPLICANT'S NAME/ADDRESS: D.R. Horton (Cori Van Dyck)
4401 Hazel Avenue, Suite 225
Fair Oaks, CA 95628
(916) 965-2200 x242; fax (916) 965-2280

I, CORI VANDYCK PROJECT MANAGER (please print and include title), agree to amend the project application, P04-037 to incorporate the attached Conditions of Approval into the requested Planning Director's Special Permit (PDSP).

I acknowledge that this project, P04-037 is subject to these PDSP Conditions of Approval. These PDSP Conditions of Approval will establish responsibilities for the monitoring of my project by various City Departments, and by other public agencies under the terms agreed upon in the PDSP Conditions of Approval. I understand that the PDSP Conditions of Approval for my project may require the expenditure of owner/developer funds where necessary to comply with the provisions of said PDSP Conditions of Approval.


Signature

PROJECT MANAGER
Title

5-21-04
Date